

APPENDIX A - DRAWING PACKAGE

Tollitt Street

24/03/2025



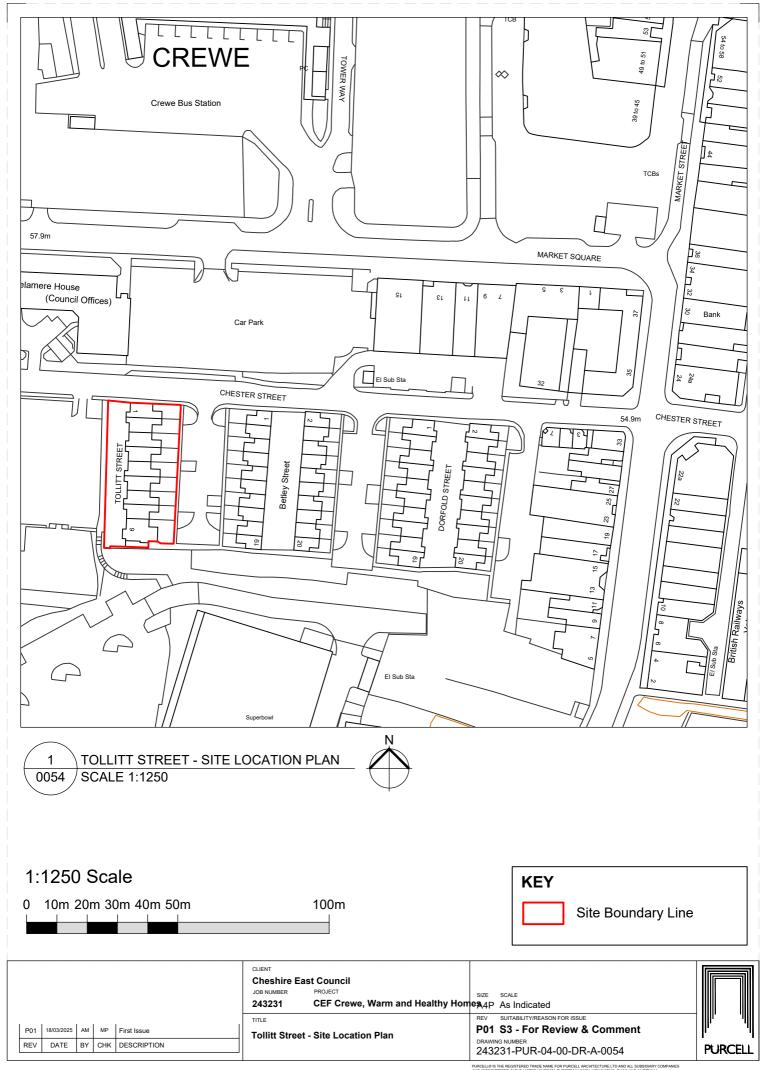

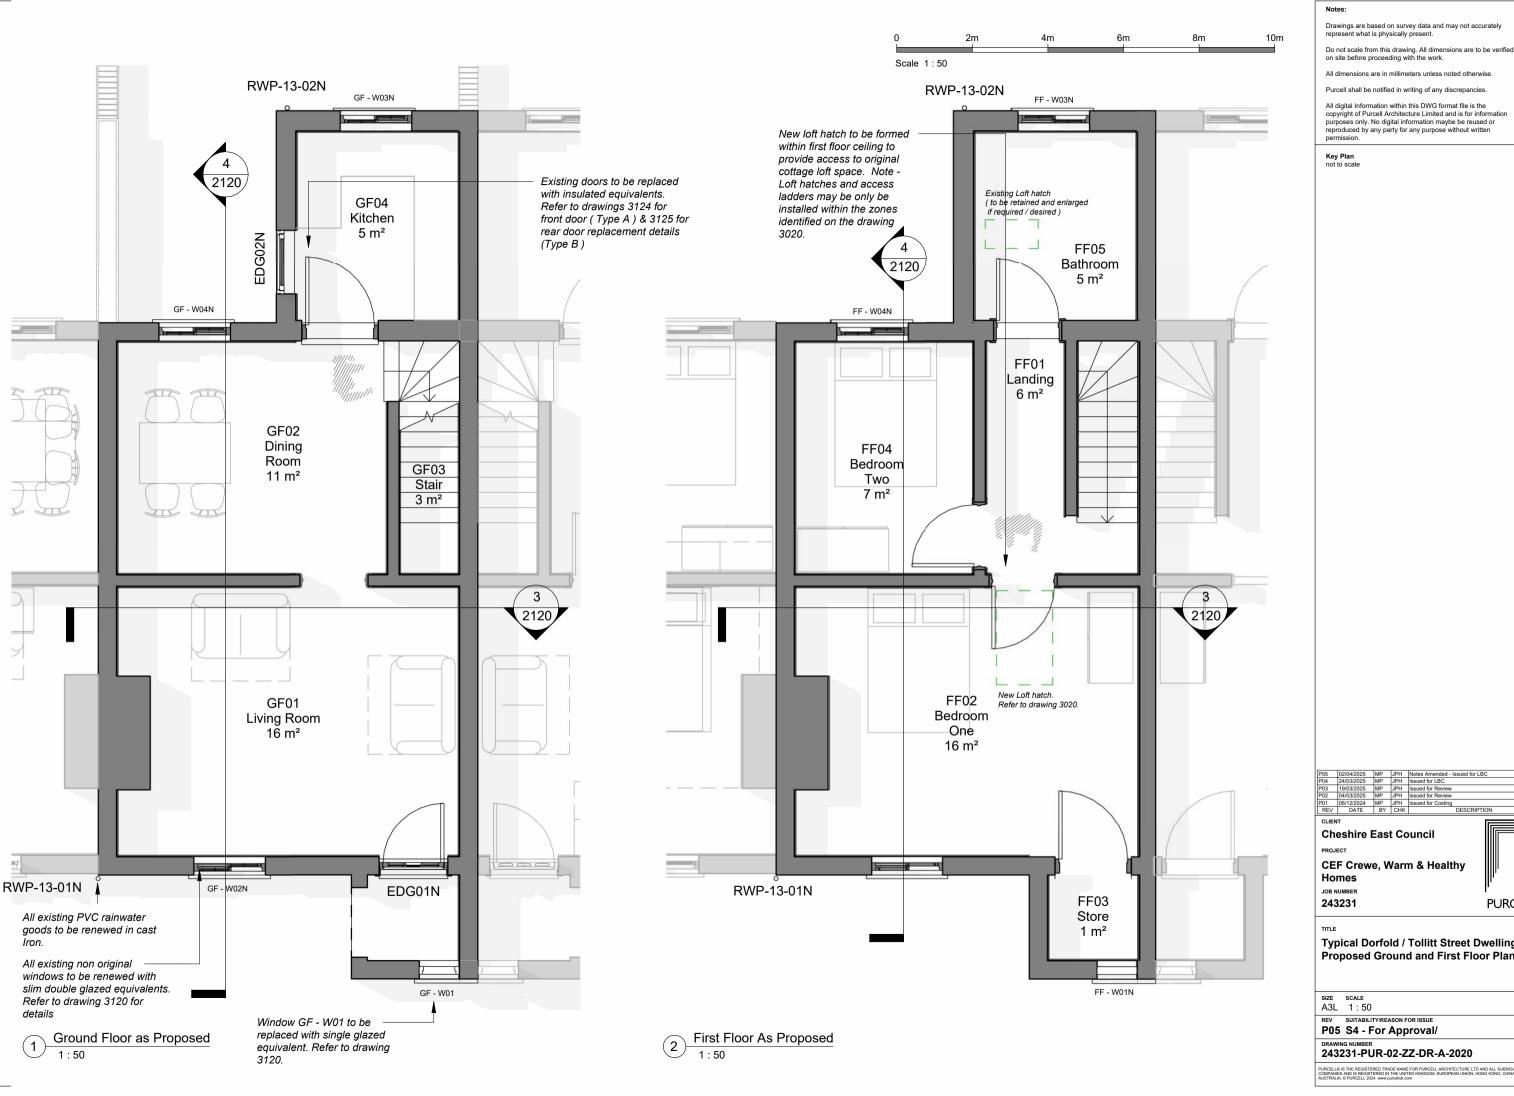


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PURCELL

Typical Dorfold / Tollitt Street Dwelling -**Proposed Ground and First Floor Plans**

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243231


PURCELL

Typical Dorfold / Tollitt Street Dwelling -Proposed Loft and Roof Plan

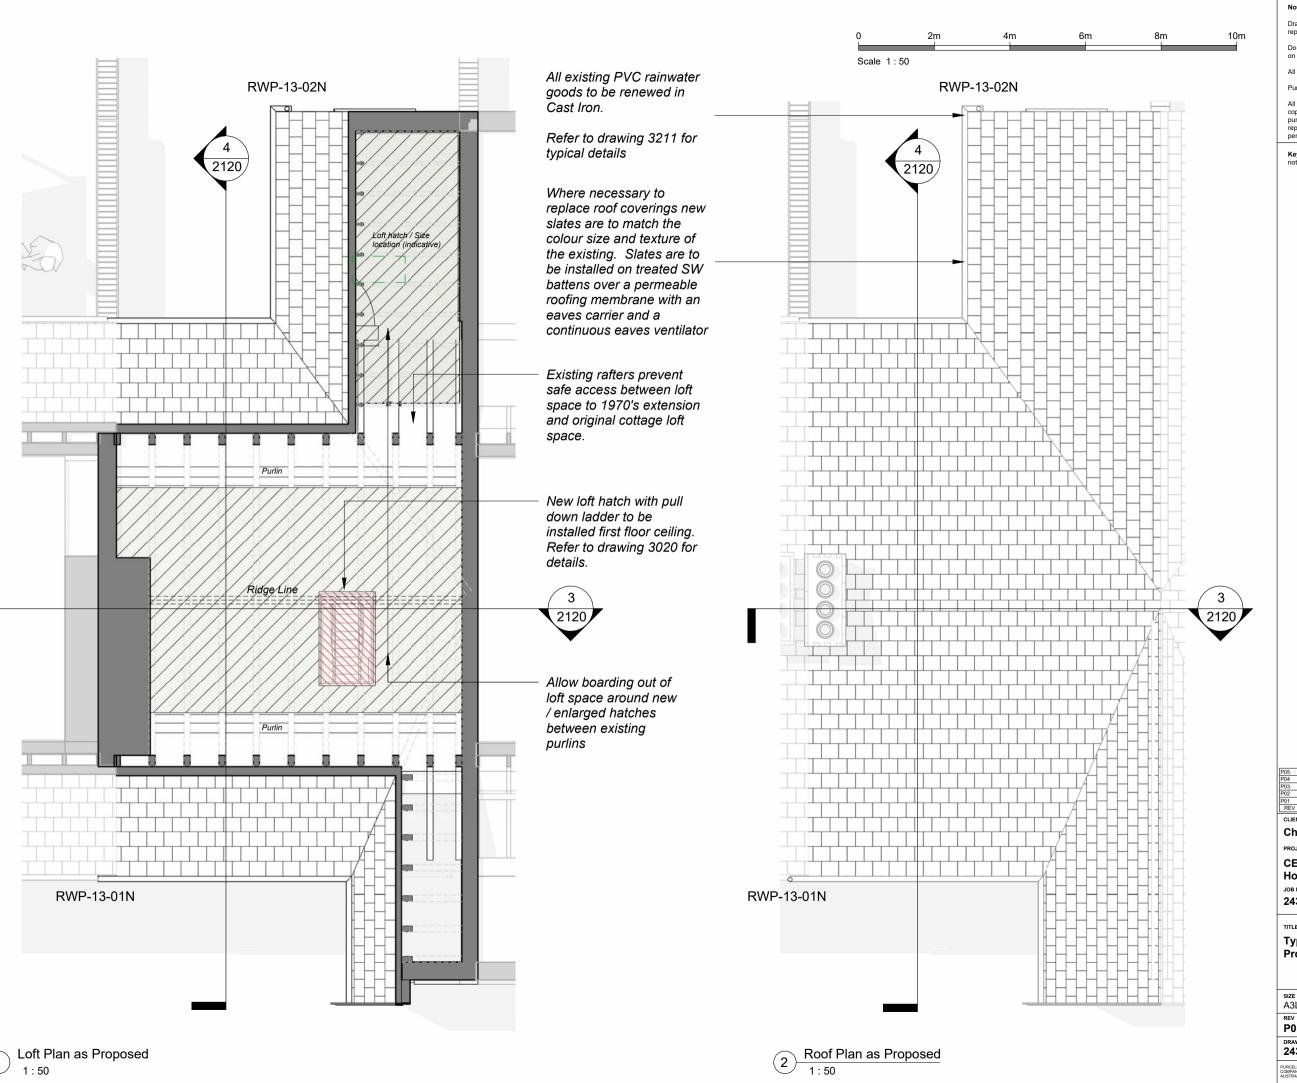SIZE SCALE A3L 1:50

rev suitability/reason for issue P05 S4 - For Approval/

DRAWING NUMBER 243231-PUR-02-ZZ-DR-A-2021

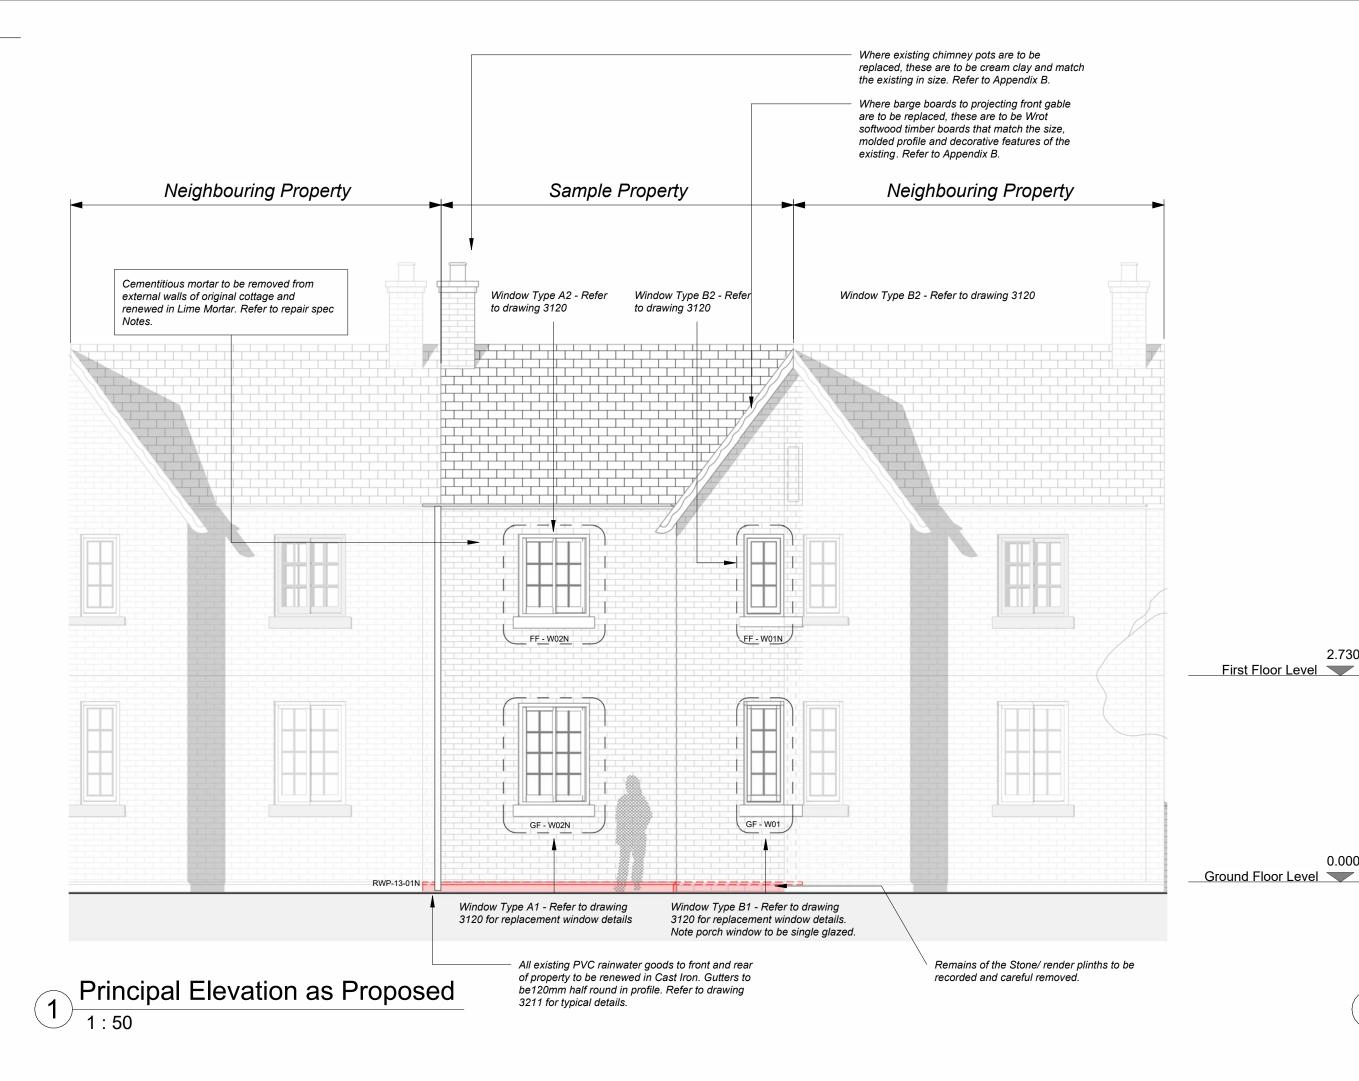

texture of the existing. Slates are to be installed on treated SW battens over a permeable roofing membrane with an eaves carrier and a continuous eaves ventilator Neighbouring Property Sample Property Neighbouring Property Window Type A2 - Refer to drawing 3120 for replacement window details All existing PVC rainwater goods to front and rear of property to be renewed in Cast Iron. Gutters to be120mm half round in profile and downpipe's to be 75mm and circular in profile. Refer to drawing 3211 for typical details. 2.730 Reclaimed Staffordshire blue brick triangular copings to back wall as existing. Where boundary walls are to be repairs copings are to match 0.000 those adjacent. Refer to drawing 3201 for blue brick reinstatement proposals to Window Type A1 - Refer to party walls. drawing 3120 for replacement window details

Scale 1:50

Where rear gates are to be replaced they are to be treated

softwood or hardwood ledged and braced gate with tongue

and grooved boarding over and a pitched hardwood capping, fitting with a Suffolk latch to match the existing


height (to the underside of the adjacent wall coping), to

match the existing.

Mineral wool Insulation with vapour control membrane (optional) to be installed within loft space to meet U-Values as required by current Building Regulations. Existing Loft Hatches to be replaced and enlarged to improve access. Refer to drawing 3020 for standard 2.730 First Floor Level EDG01N Living Room Existing front and rear external doors to be replaced with insulated equivalents. Refer to drawings 3124 for Front Door replacement (Type A) details. Ground Floor Level

GA Section as Proposed A-A

1:50

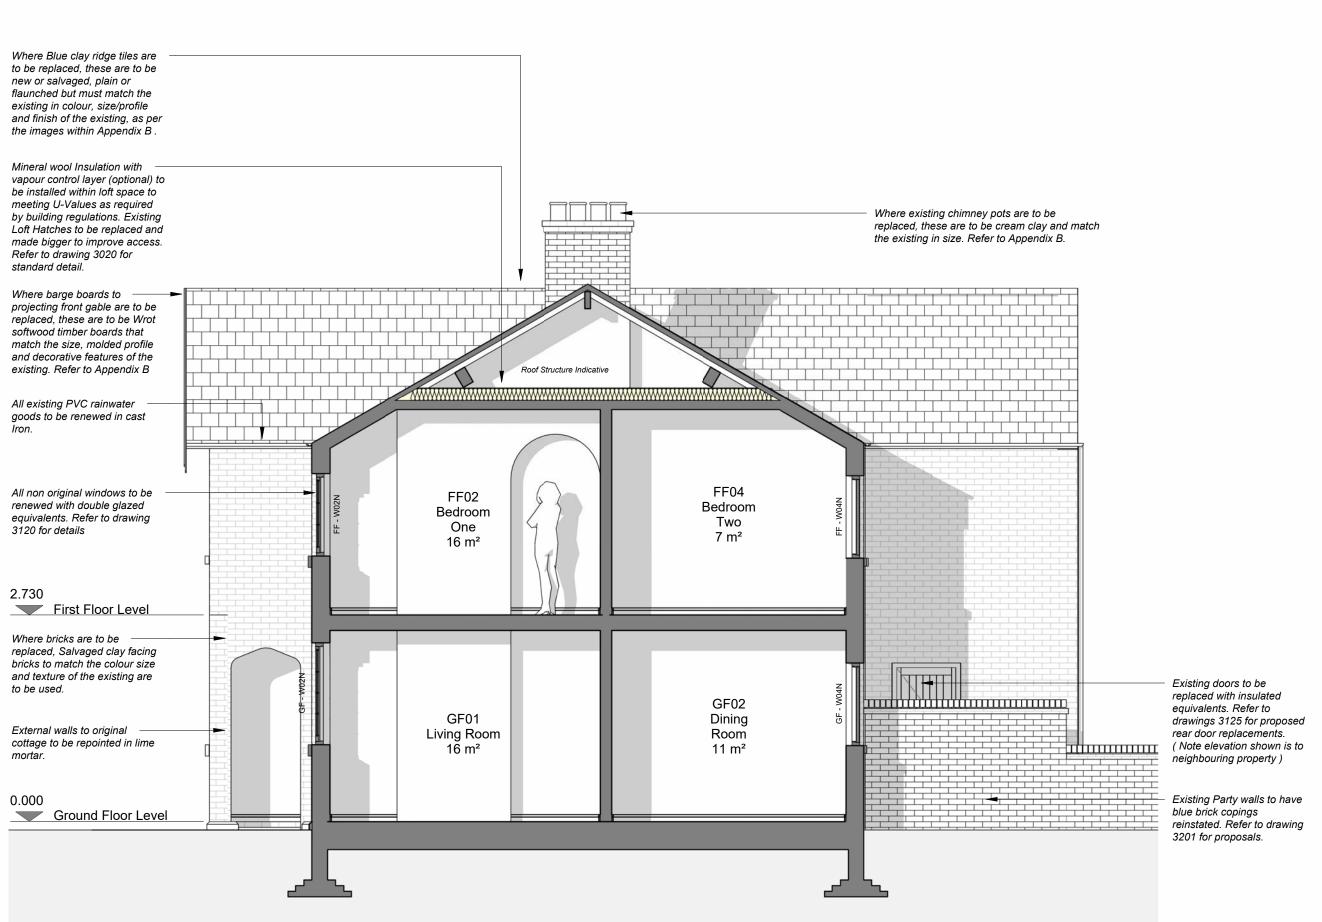

GA Section as Proposed B-B

1:50

Where necessary to replace roof coverings new slates are to match the colour size and

Rear Elevation as Proposed

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not to scale **NOTES**

purpose without written permission.

Removal of cementitious pointing of brickwork with reponting with Lime Mortar

1. Removal of existing cementious mortar and cement patch repairs

- Where facades are to be repointed, rake out motar joints well to a depth of 25mm minimum using chisels or hacksaw blades of appropriate width so as not to damage existing arises and flush out with water. Remove cement pointing by using hand tools such as quirks or narrow chisels. Remove loose particles to make a good key for the new mortar. Clean out joints using dry air sprays and non ferrous or stiff bristle brushes.
- Remove cement patch repairs using hand tools only. This is best achieved by continual gentle tapping with a hammer at the centre of the repair until the different mechanical properties between the brick and the cementitious mix causes the two to part without damage. The process is lengthy and time should be allowed for it.
- Care is to be taken to avoid damage to the substrate, particularly where the repairs are deep and well-adhered. Avoid damage to edges of sound

Repointing in Lime mortar

- Careful and sympathetic repointing is of the utmost importance in preserving the colour, texture and general character of old brickwork. Strong cement mortars are dark and harsh in colour; also they shrink and pull away the edges of the bricks. Flush pointing is unsuited to the irregularly shaped edges and faces of early brickwork and any form of struck pointing gives a hard and mechanical appearance to the wall. The following instructions are to be brought to the notice of every bricklayer and mason employed on the work and are to be carefully and fully carried out.
- Press the new mortar well into the joints to assist adhesion and to ensure that no voids are left. When the joints are filled the mortar is to finish slightly recessed from the general face of the brickwork so that the mortar does not encroach upon the irregular arrisses or spread over any worn or rounded edges of the bricks or stone.
- As soon as the mortar has taken the initial set it is to be stippled with a stiff bristle brush to produce a slightly rough surface.

3. Lime Mortar Spec mix spec

1 part Hydraulic Lime, 3.5 NHL

1 part pit sand sieved to <2.36 mm. (Nosterfield or similar approved) 1/2 part fine red sand sieved to <600 microns 1 parts silica quartz sand sieved to <1000 microns (Leighton Buzzard or

Add to the mix crushed chalk reference: "CKC", obtained from Lime Green Products

4. Lime Mortar Spec mix Photo

similar approved)



P05	02/04/2025	MP	JPH	Notes Amended - Issued for LBC
P04	24/03/2025	MP	JPH	Issued for LBC
P03	19/03/2025	MP	JPH	Issued for Review
P02	04/03/2025	MP	JPH	Issued for Review
P01	21/11/2024	MP	MP	Issued for Information
REV	DATE	BY	CHK	DESCRIPTION
	P04 P03 P02 P01	P04 24/03/2025 P03 19/03/2025 P02 04/03/2025 P01 21/11/2024	P04 24/03/2025 MP P03 19/03/2025 MP P02 04/03/2025 MP P01 21/11/2024 MP	P04 24/03/2025 MP JPH P03 19/03/2025 MP JPH P02 04/03/2025 MP JPH P01 21/11/2024 MP MP

CLIENT

Cheshire East Council

CEF Crewe, Warm & Healthy

243231



Typical Dorfold / Tollitt Street Dwelling -**Proposed Elevations and Sections**


SIZE SCALE


A1L 1:50

REV SUITABILITY/REASON FOR ISSUE P05 S4 - For Approval


DRAWING NUMBER 243231-PUR-02-ZZ-DR-A-2120


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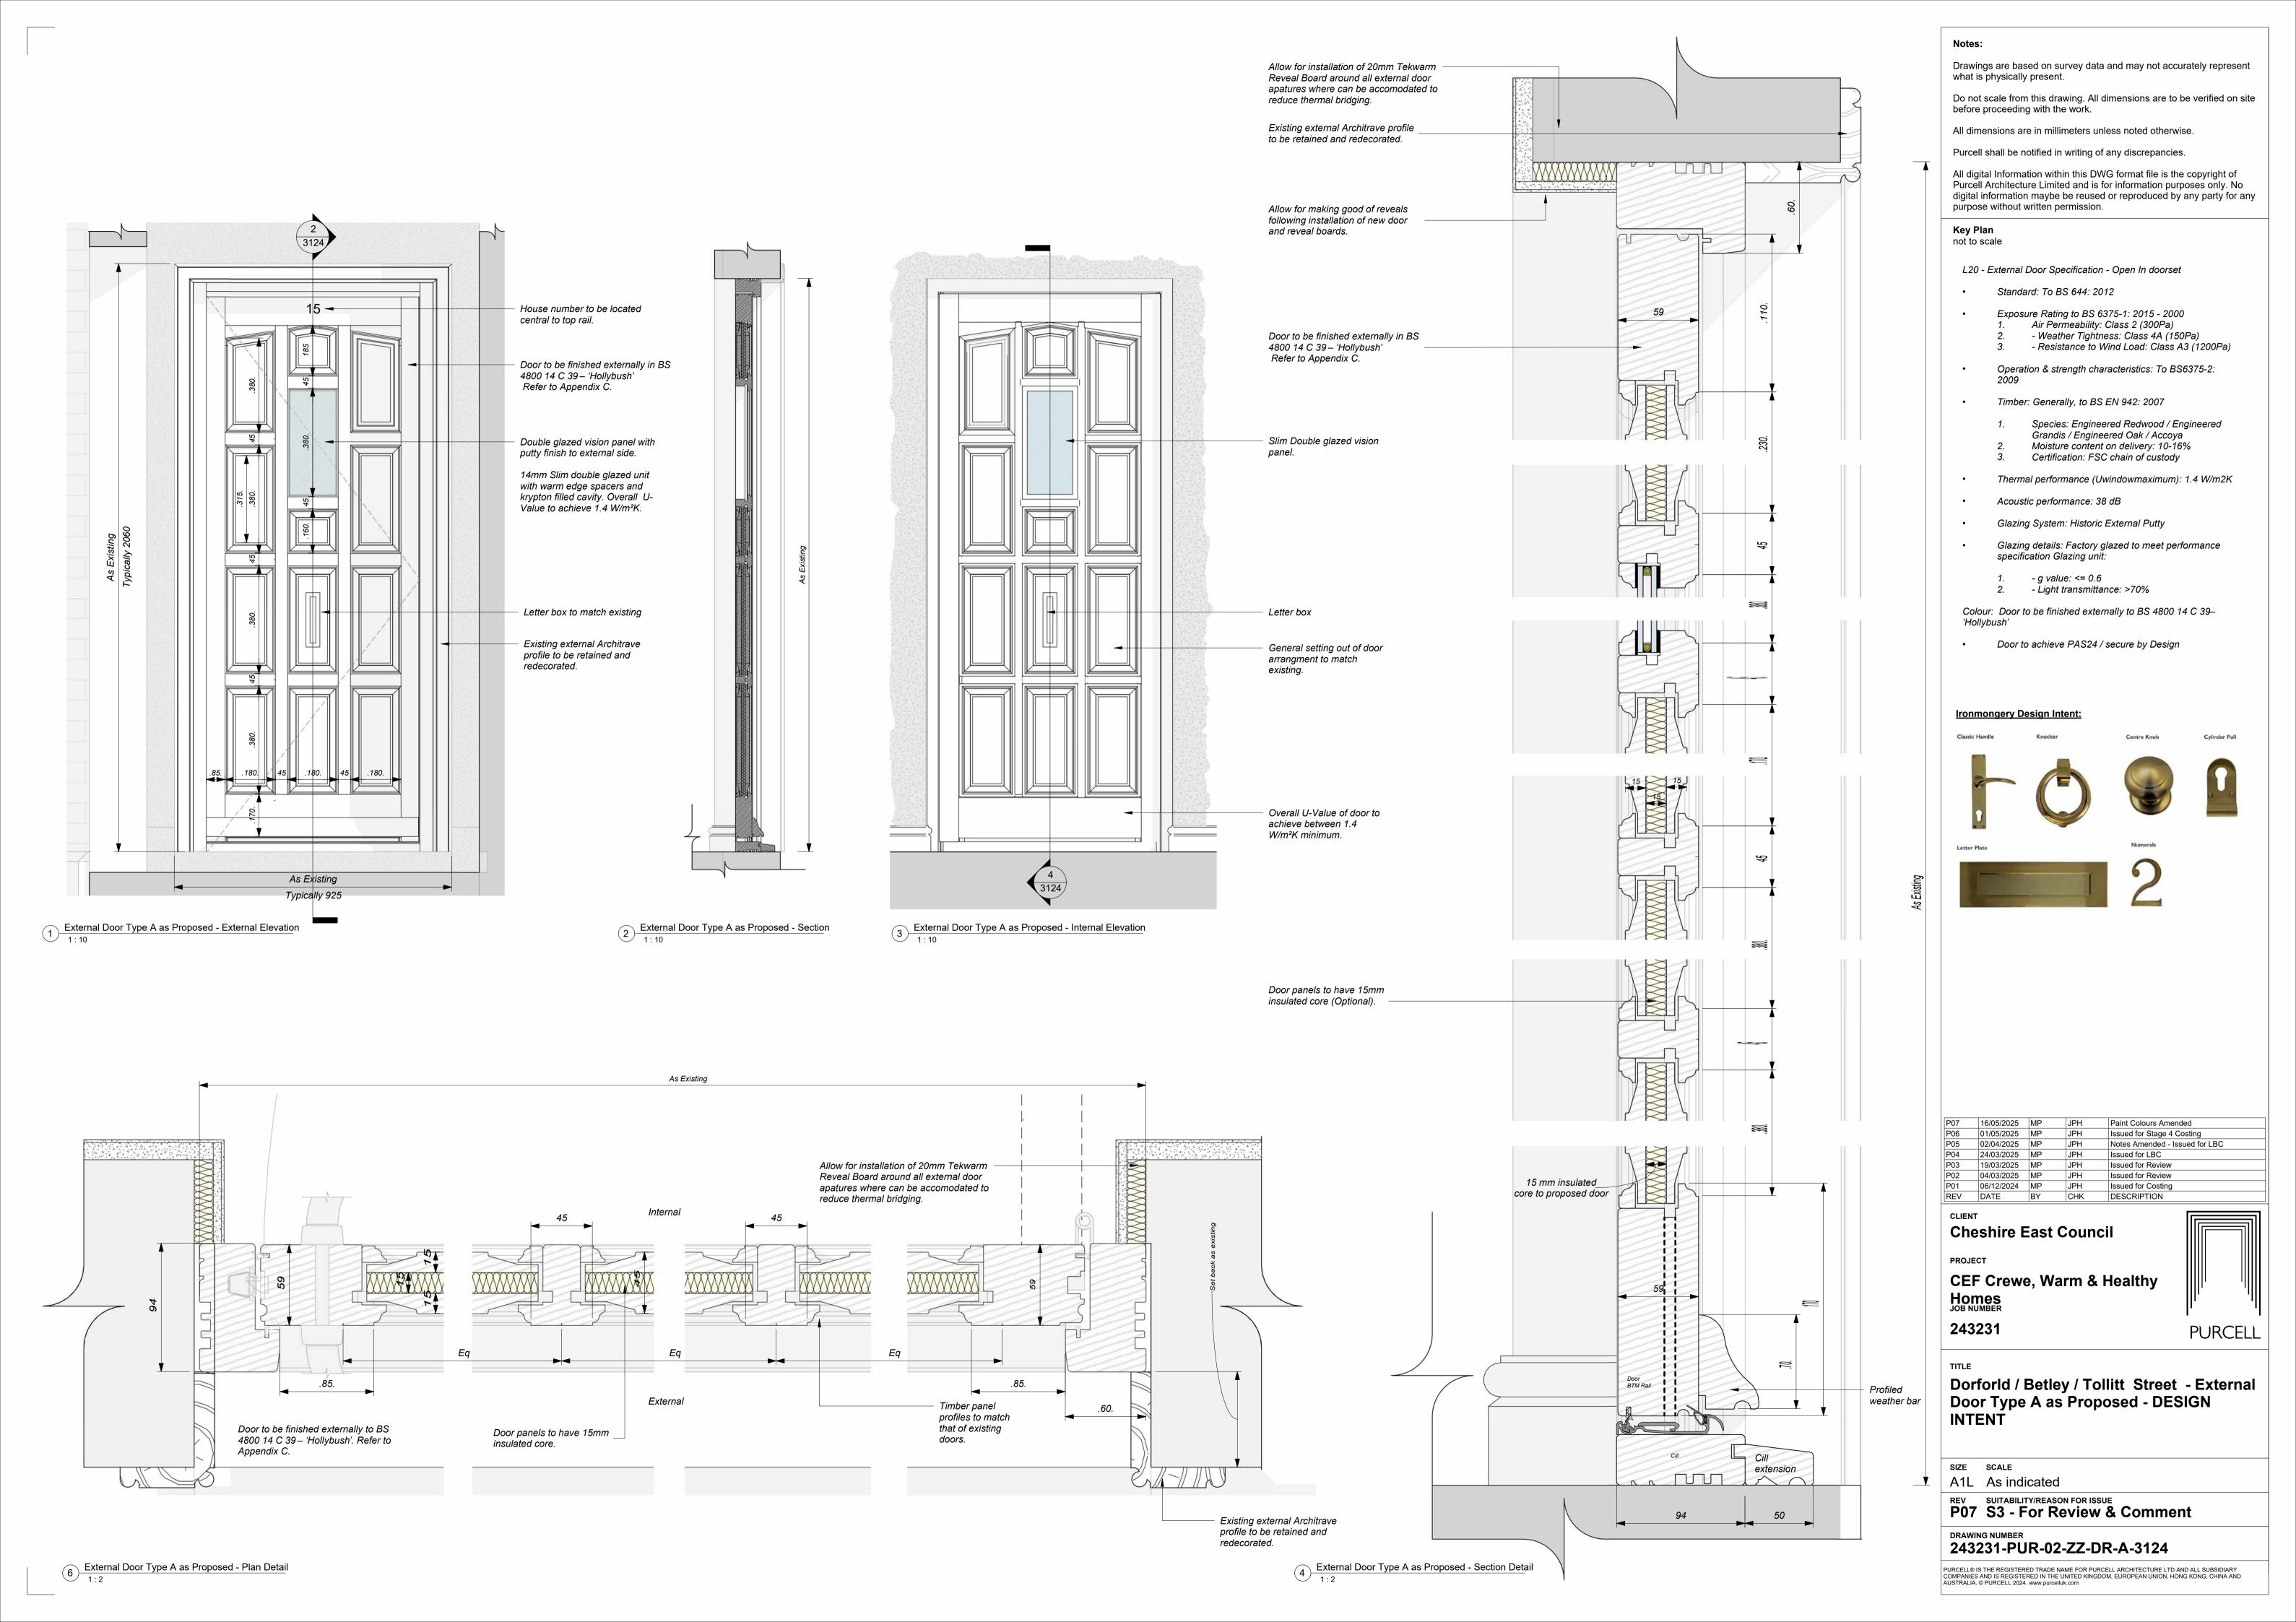


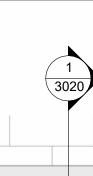


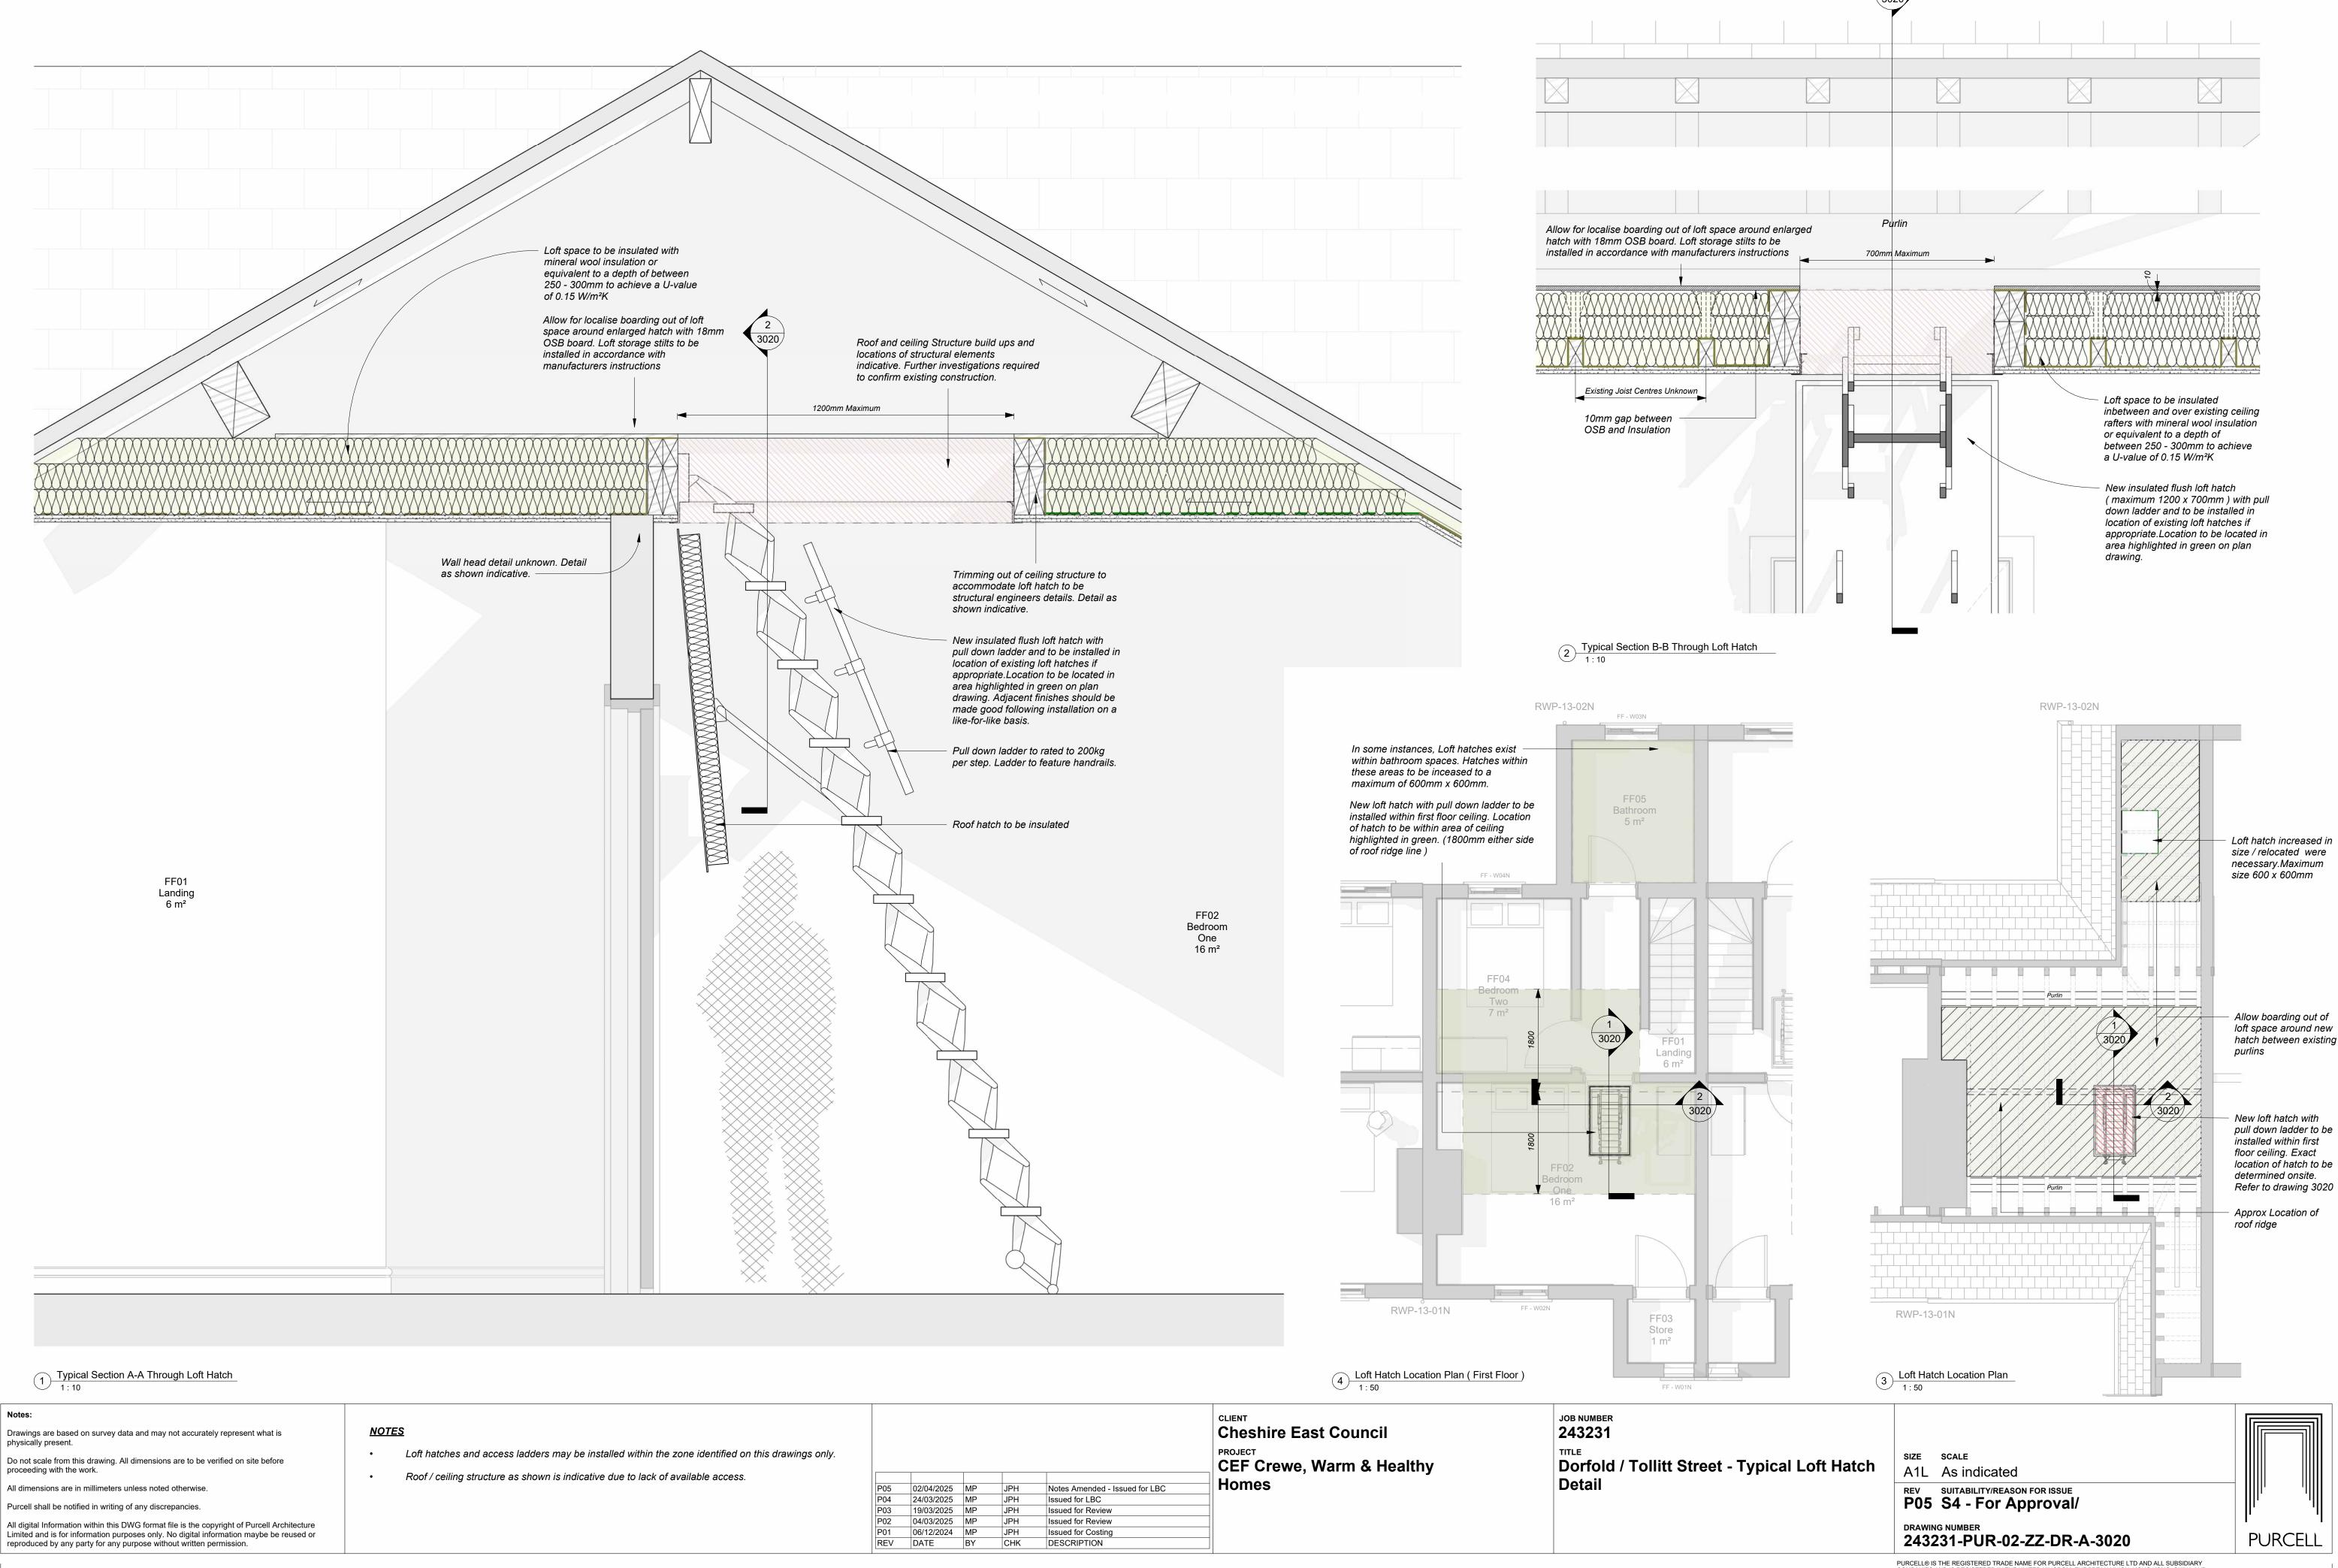
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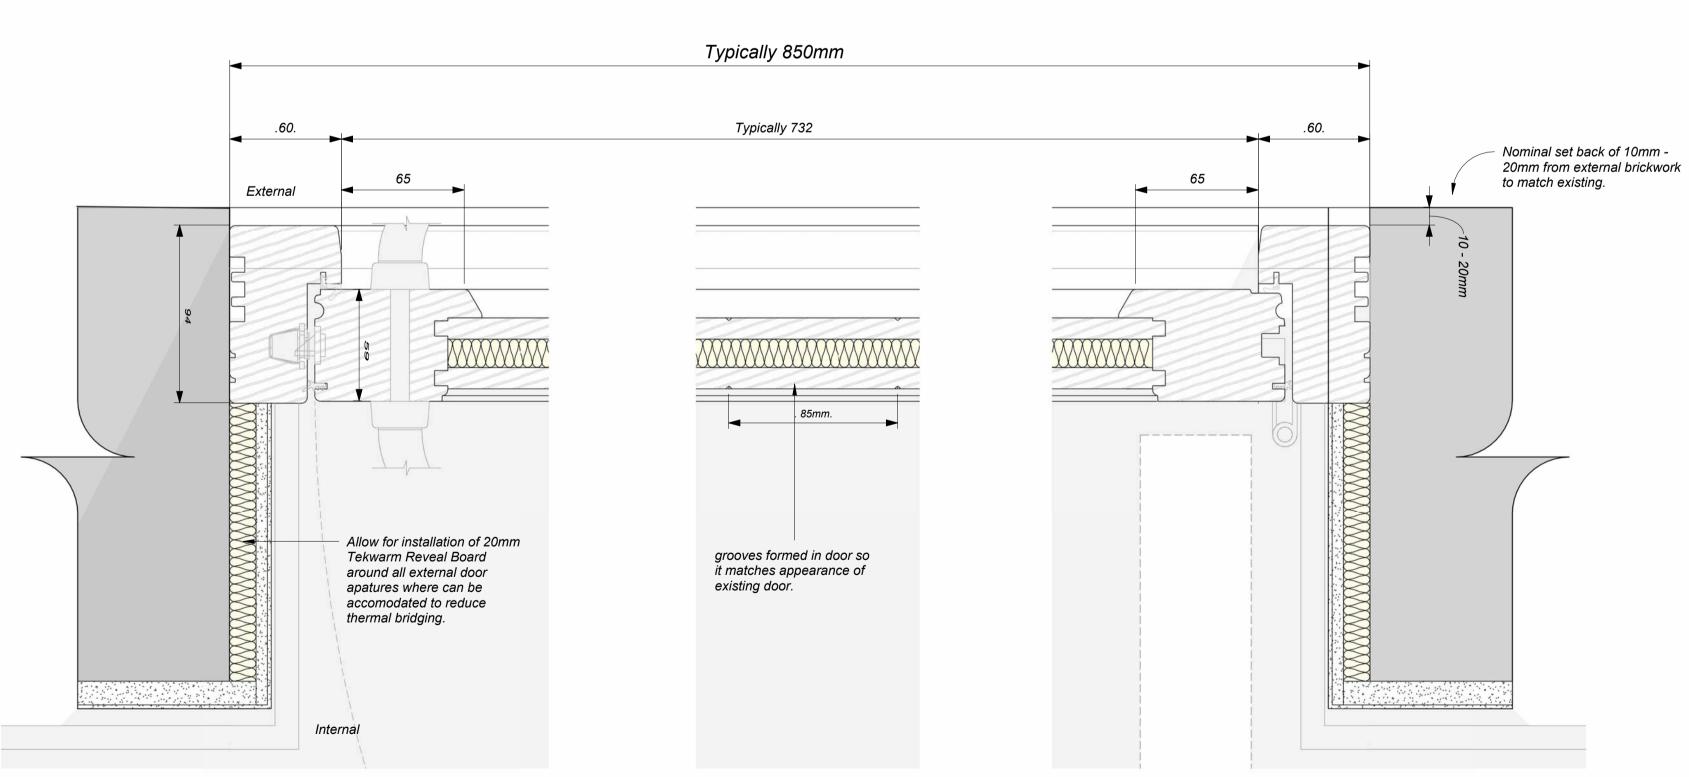




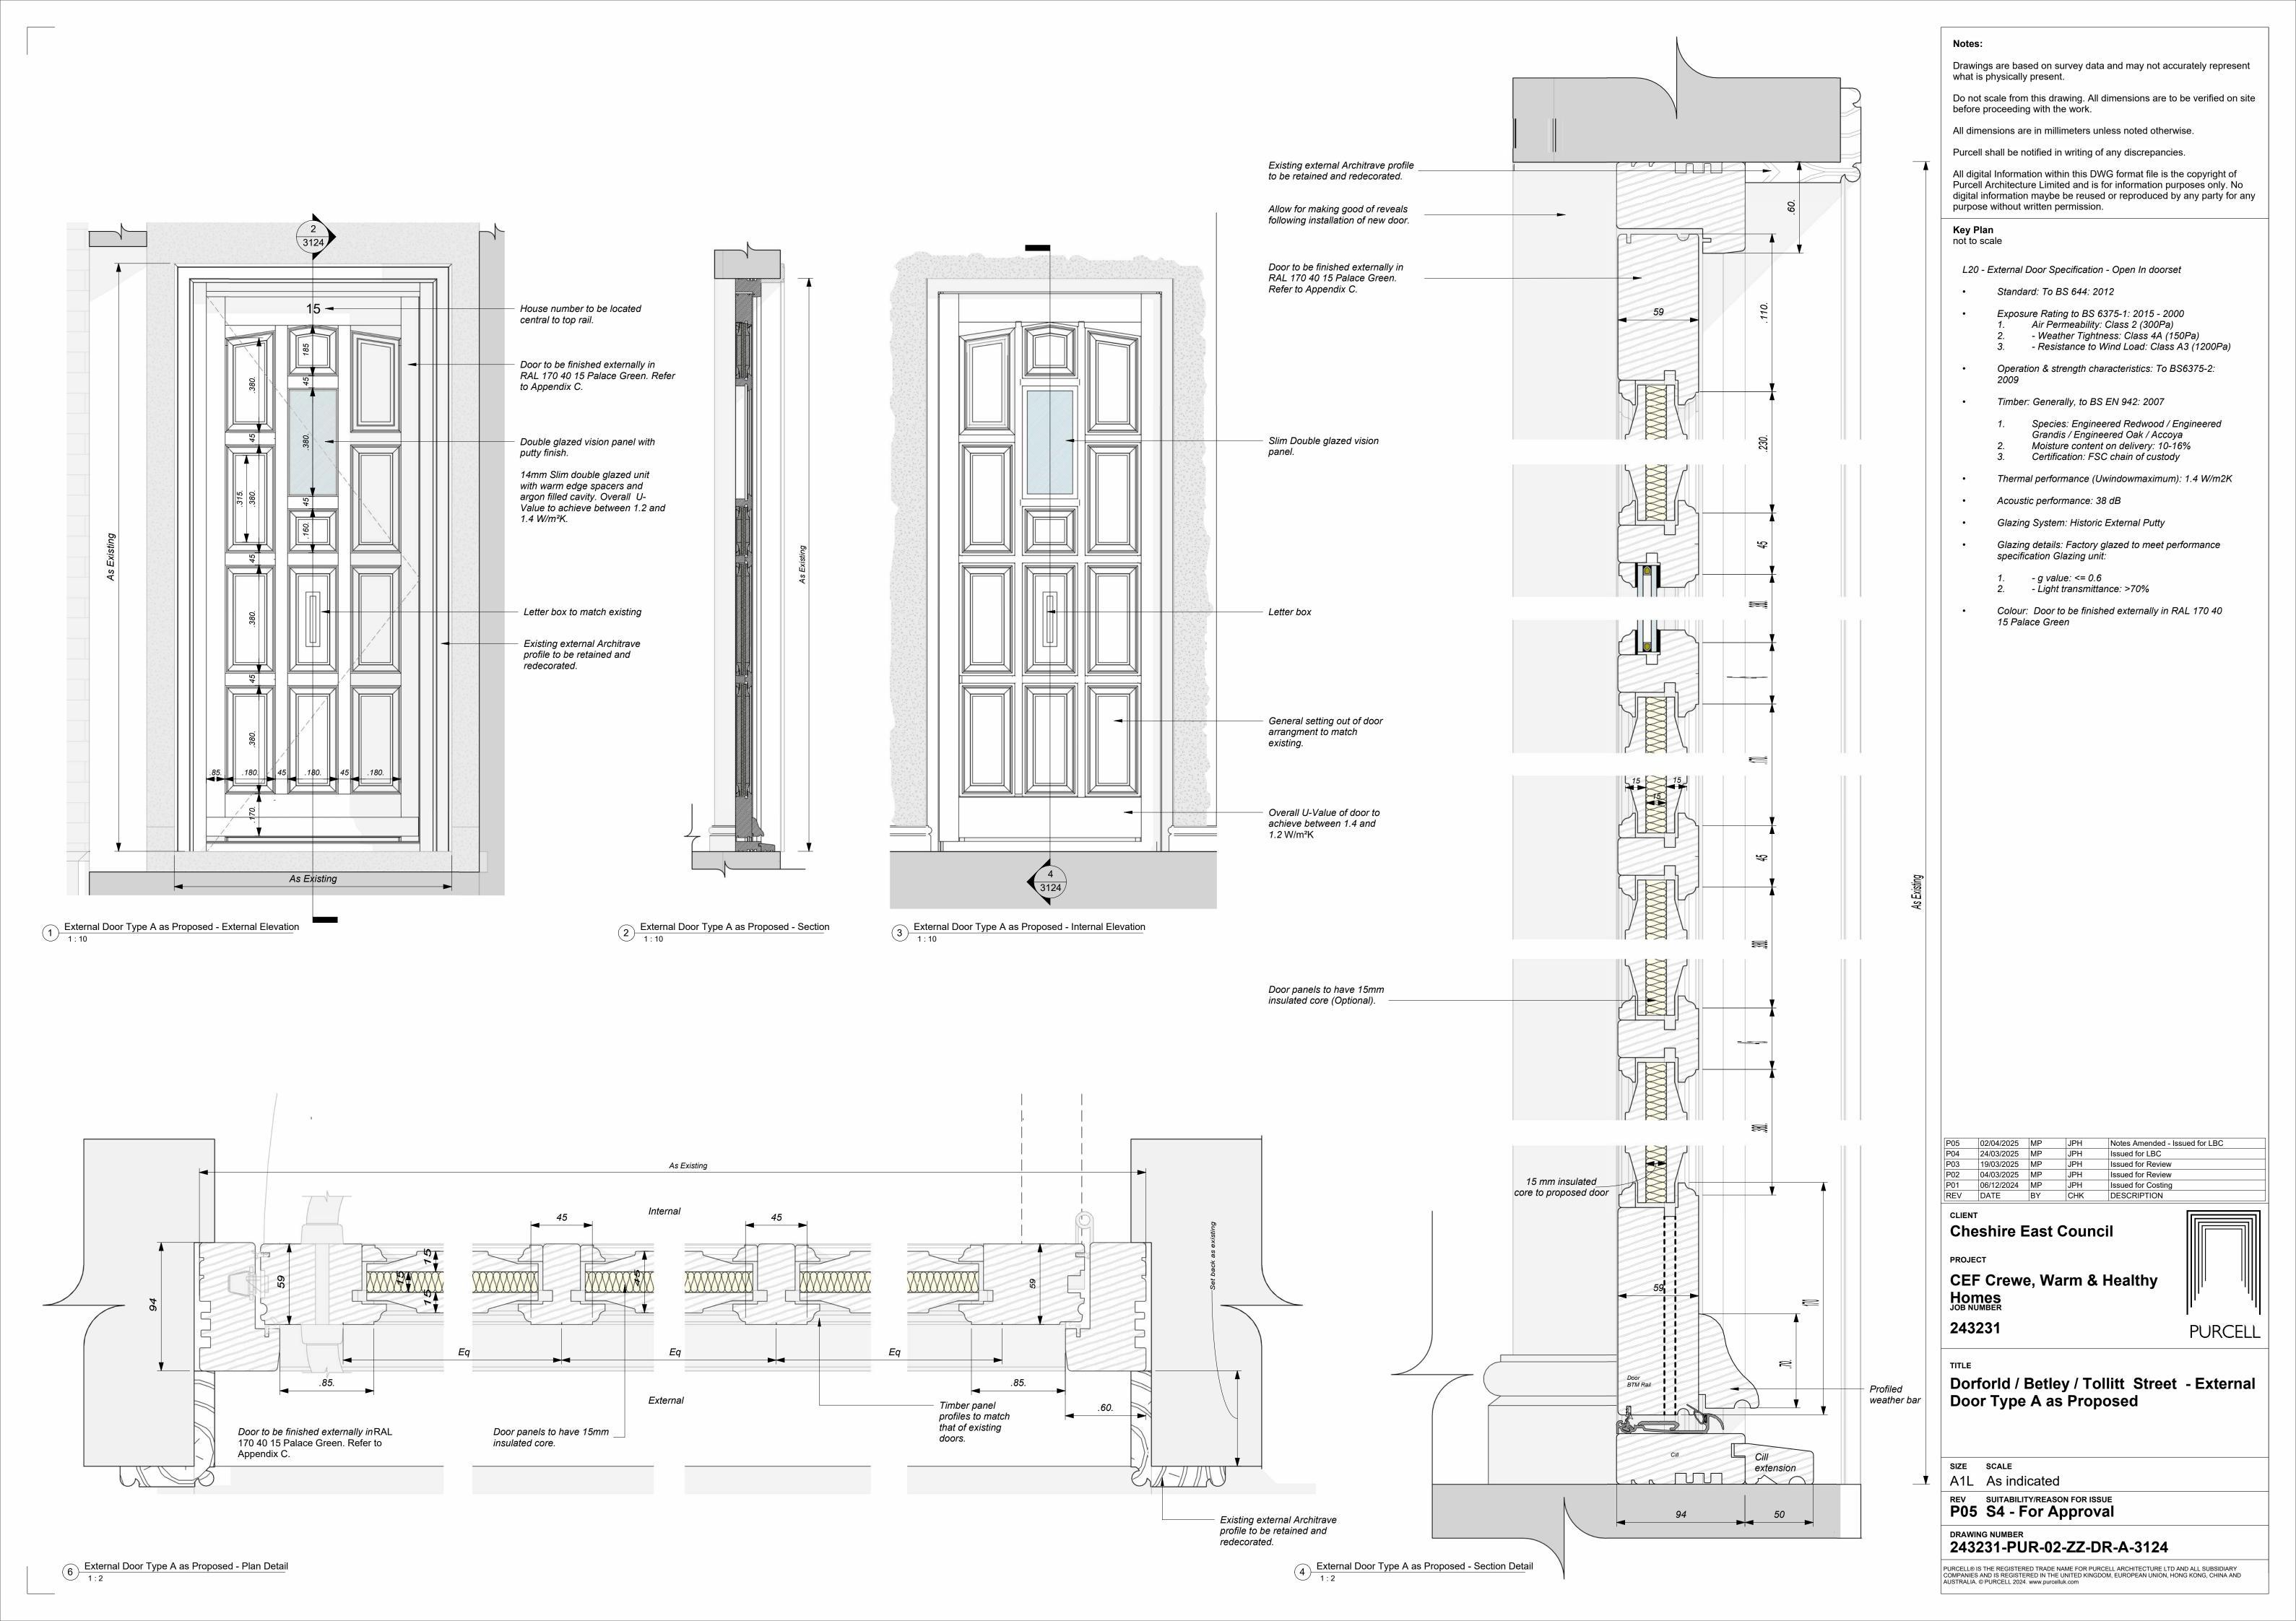


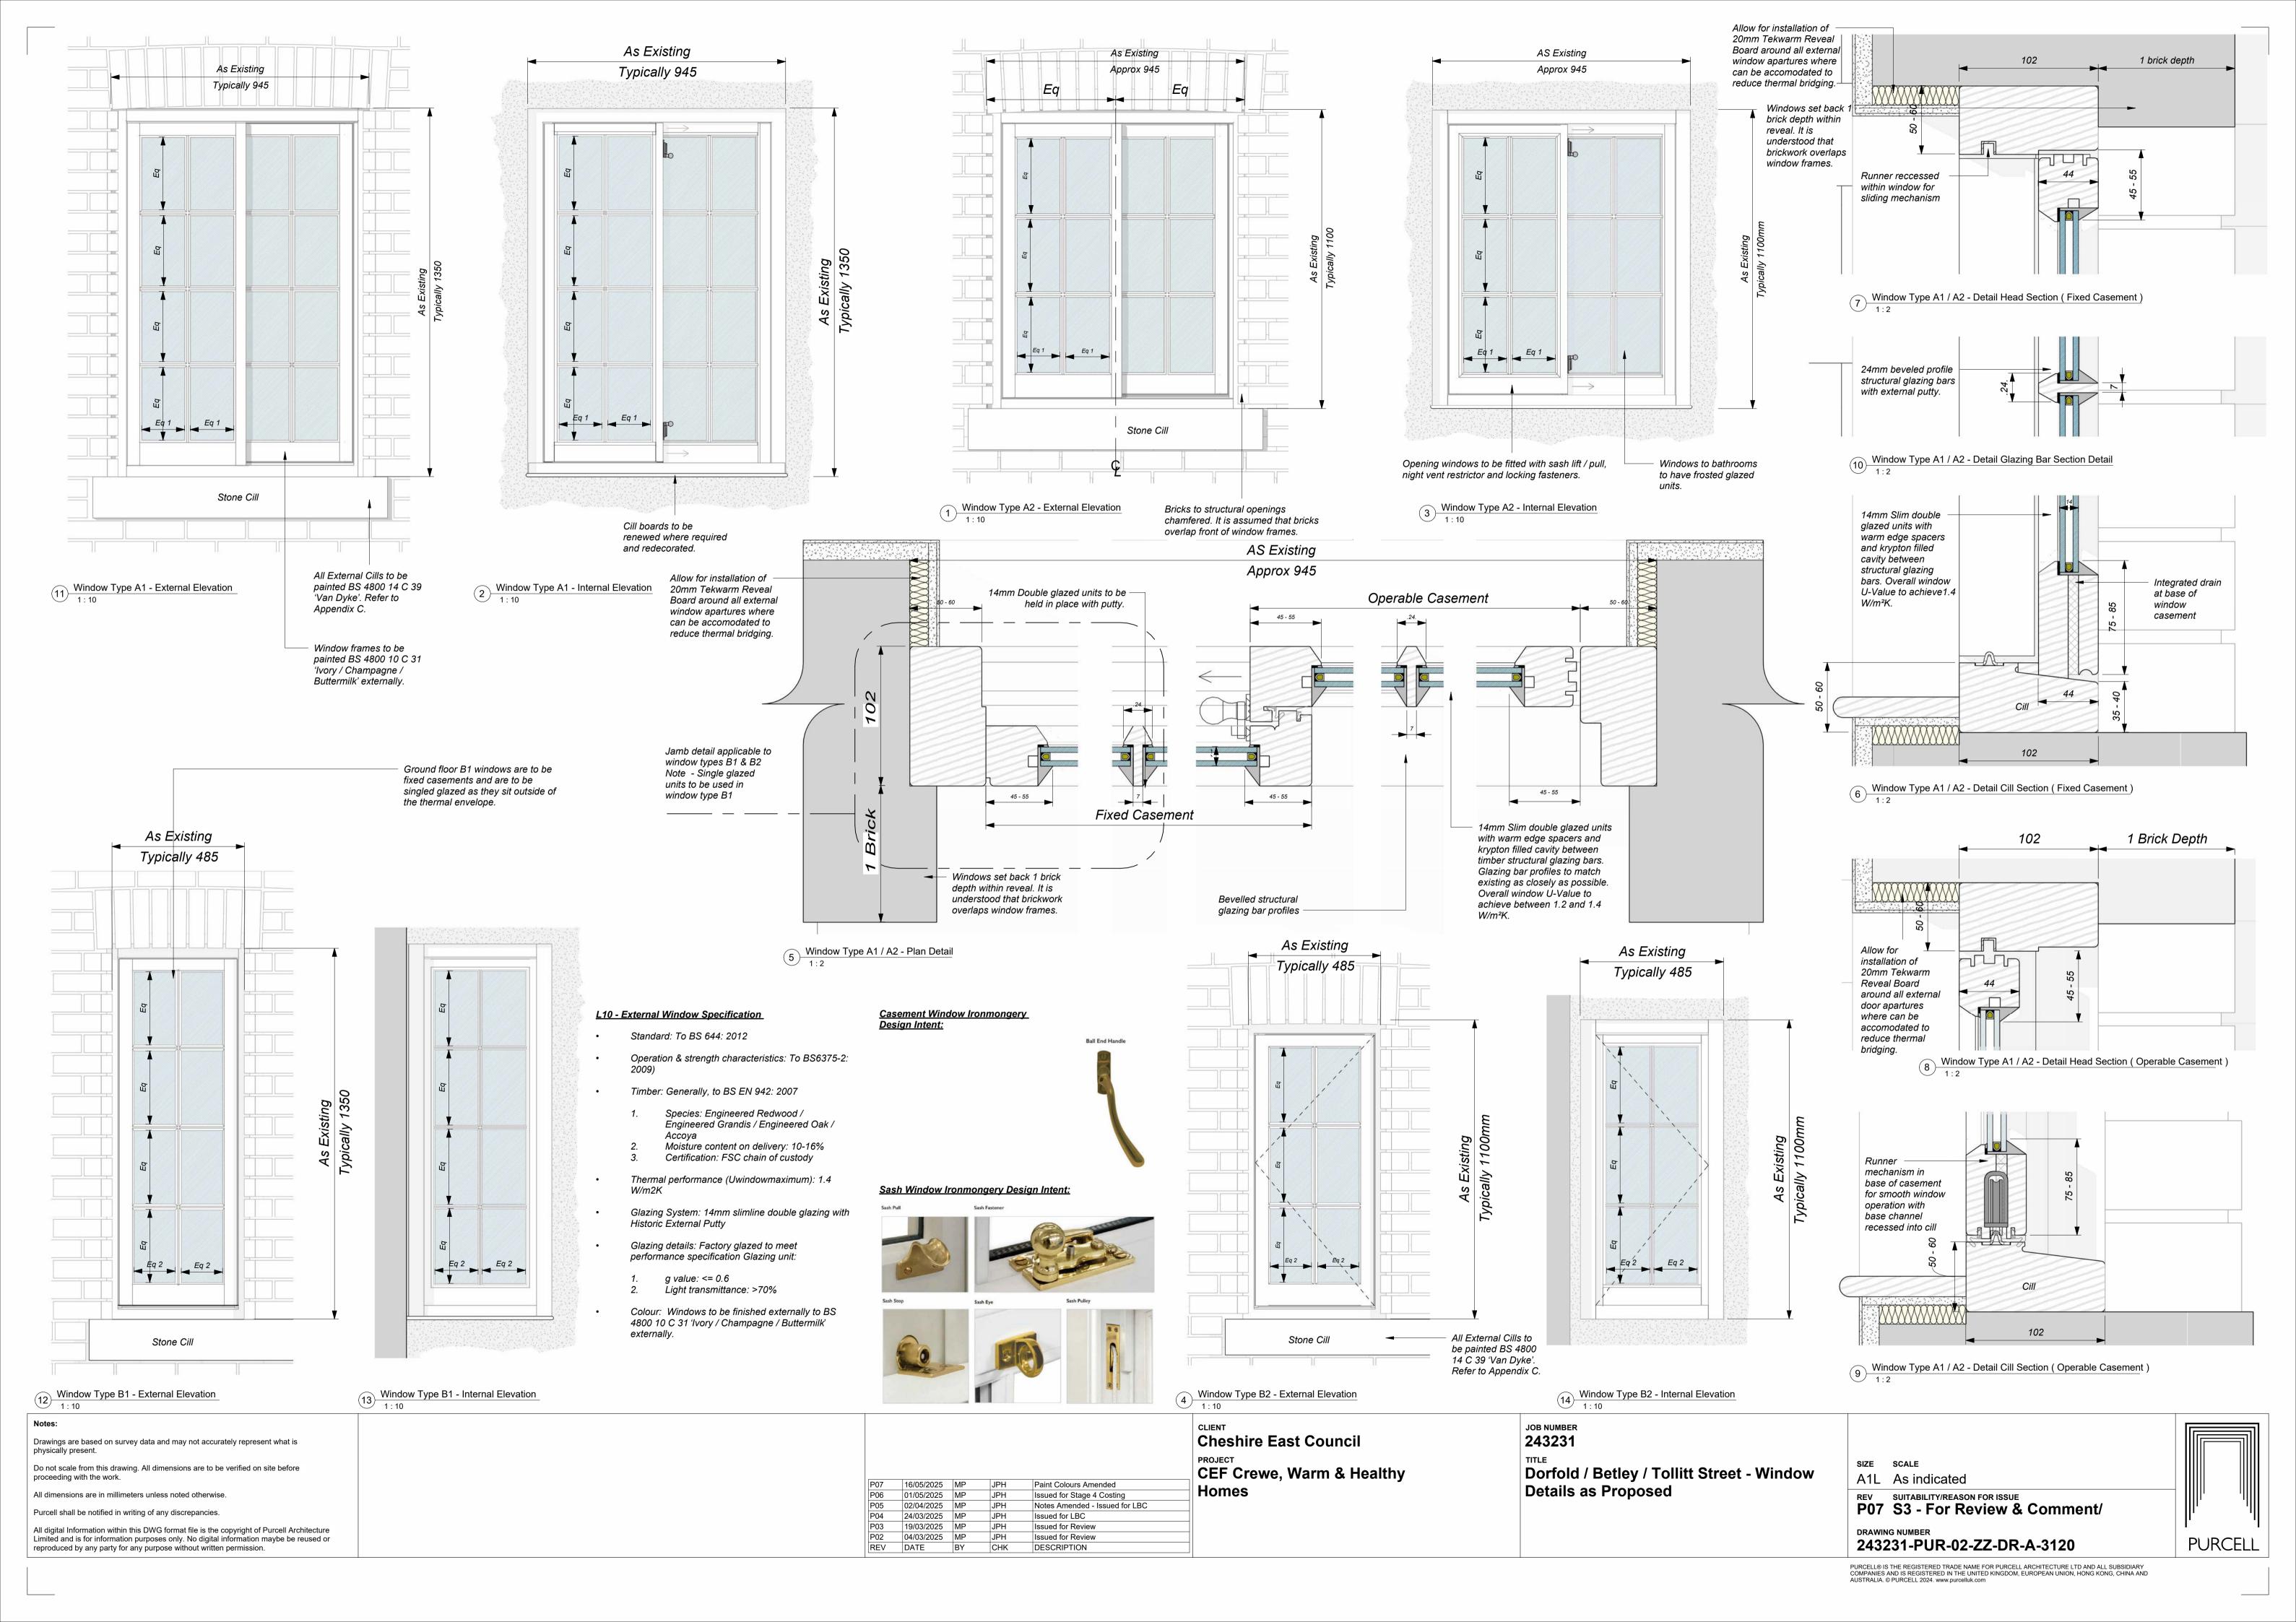

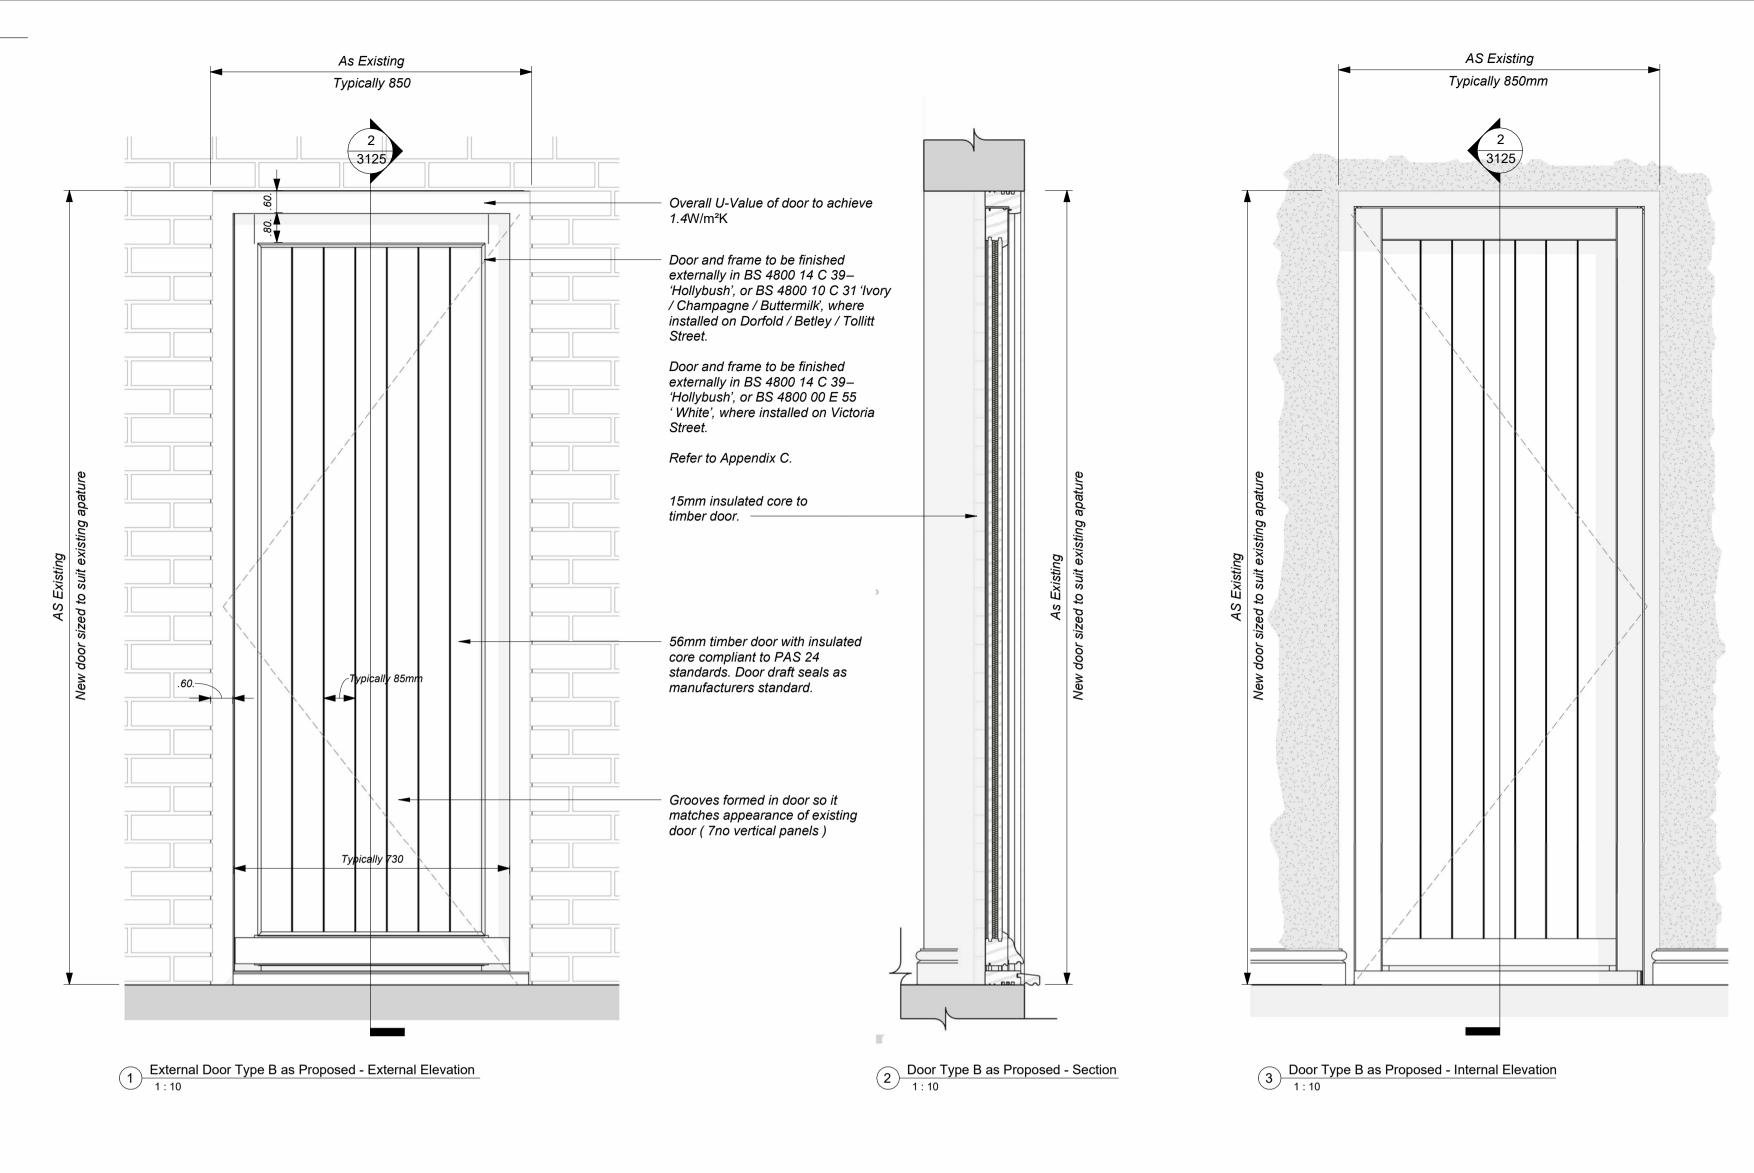

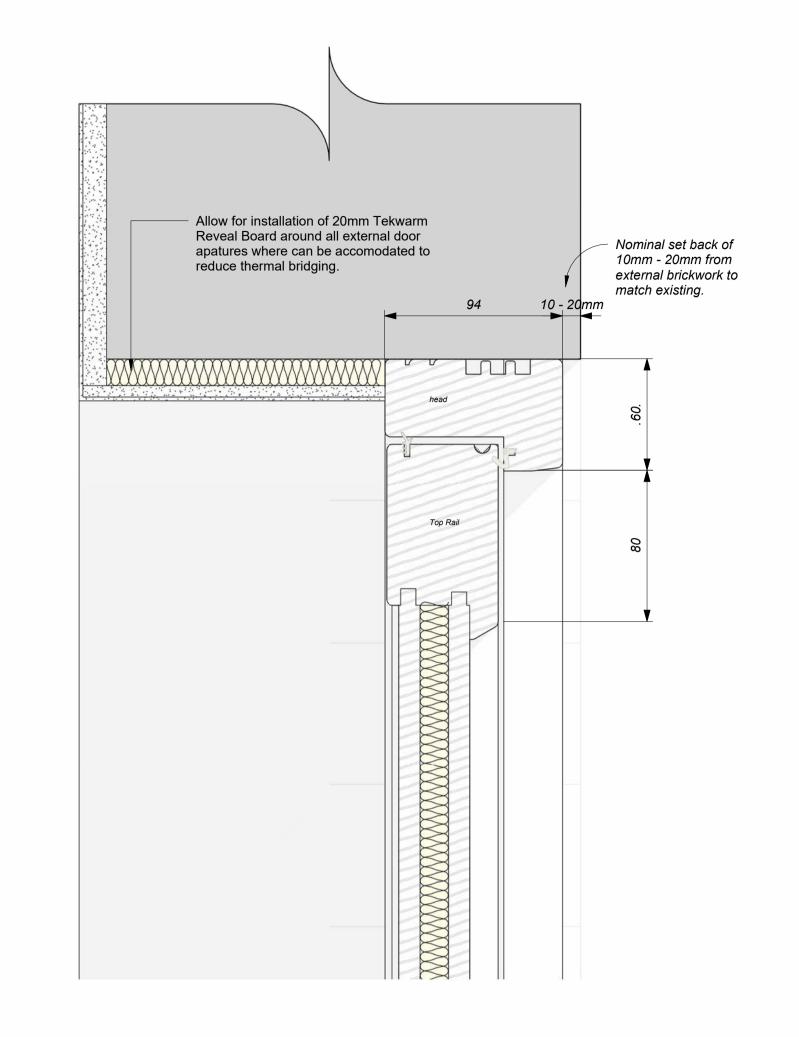

Door Type B as Proposed - Plan Detail
1:5

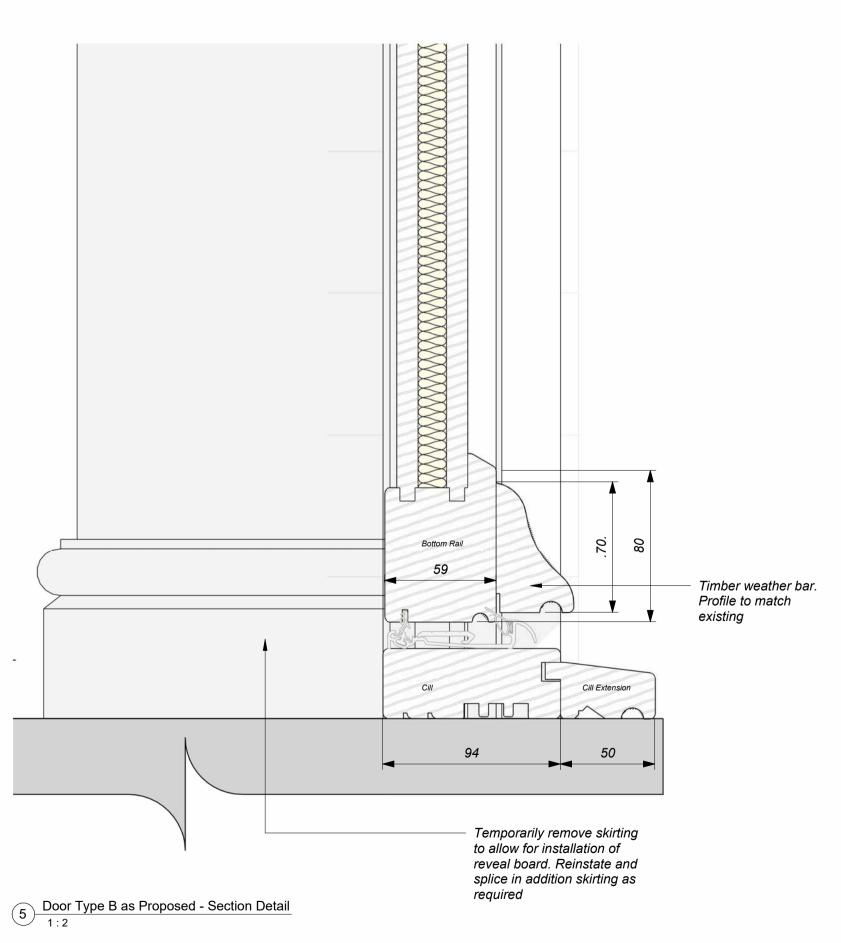

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Key Plan not to scale

L20 - External Door Specification - Open In doorset

Standard: To BS 644: 2012

Exposure Rating to BS 6375-1: 2015 - 2000 1. Air Permeability: Class 2 (300Pa)

- Weather Tightness: Class 4A (150Pa)

- Resistance to Wind Load: Class A3 (1200Pa)

Operation & strength characteristics: To BS6375-2: 2009

Species: Engineered Redwood / Engineered Grandis / Engineered Oak / Accoya

Moisture content on delivery: 10-16% Certification: FSC chain of custody

Timber: Generally, to BS EN 942: 2007

Thermal performance (Udoormaximum): 1.4 W/m2K

15mm insulated core to door

Acoustic performance: 38 dB

Security: Certified to PAS 24 and Secured by Design

Colour: Door to be finished externally in RAL 170 40 15 Palace Green or RAL 1014 'Classic Ivory' . Internal finish to be 9003 Signal White.

Ironmongery Design Intent:









P06	16/05/2025	MP	JPH	Paint Colours Amended	
P05	01/05/2025	MP	JPH	Issued for Stage 4 Costing	
P04	02/04/2025	MP	JPH	Notes Amended - Issued for LBC	
P03	24/03/2025	MP	JPH	Issued for LBC	
P02	19/03/2025	MP	JPH	Issued for Review	
P01	06/12/2024	MP	JPH	Issued for Costing	
REV	DATE	BY	CHK	DESCRIPTION	
Ch	eshire E	∃ast	Coun	cil	

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Dorfold / Betley / Tollit / Victoria Street -External Door Type B as Proposed -**DESIGN INTENT**

SIZE SCALE

A1L As indicated


P06 S3 - For Review & Comment

DRAWING NUMBER


243231-PUR-02-ZZ-DR-A-3125

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Typical Back Yard Plan as Proposed
1:50

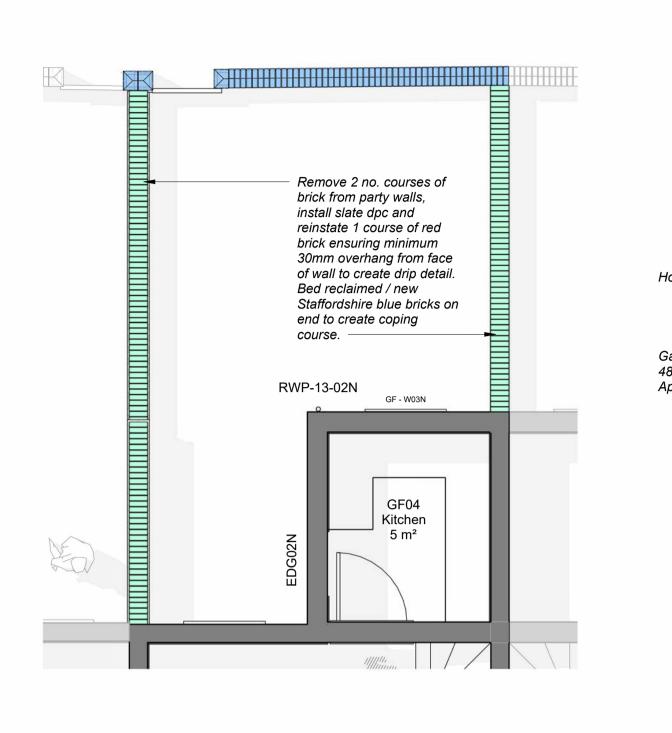


1 Typical Rear Elevation as Proposed 1:50

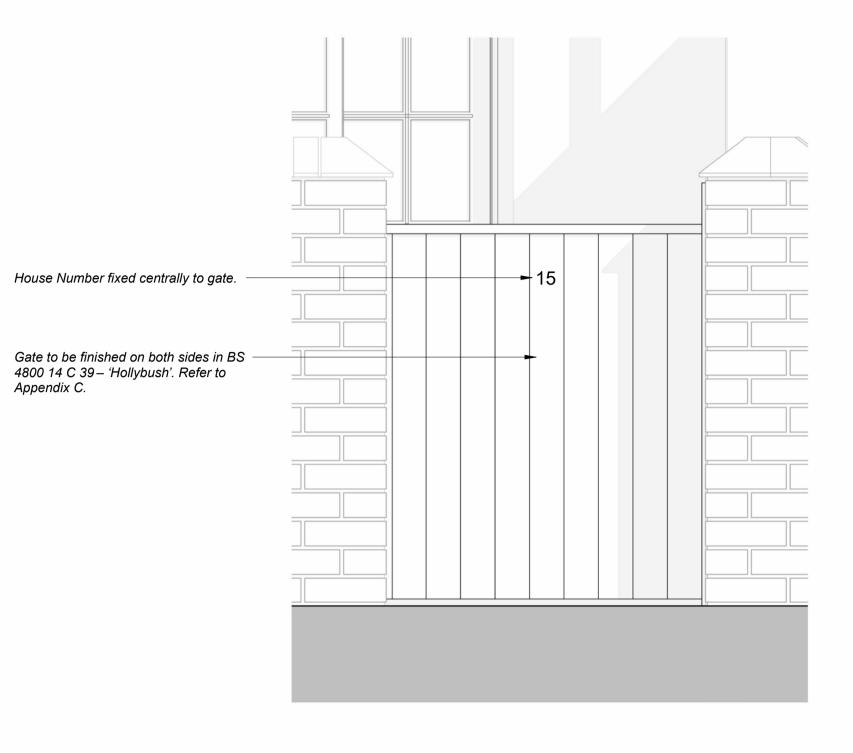

4 Typical Coping Detail to party walls
NTS



Typical Coping Detail to Rear / Side Boundary walls
NTS

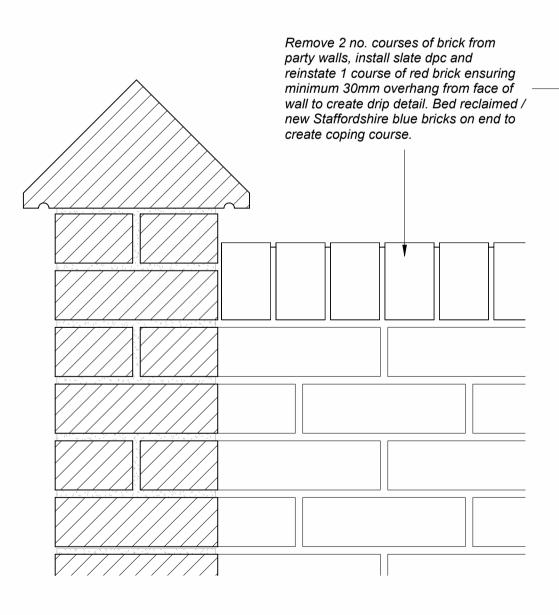

5 Boundary to Party Wall Connection Detail 1:5


8 Section Through Party Wall as Proposed 1:5

Remove 2 no. courses of brick from party walls, install slate dpc and reinstate 1 course of red brick ensuring minimum 30mm overhang from face of wall to create drip detail. Bed reclaimed / new Staffordshire blue bricks on end to create coping course.

Party Wall Elevation as Proposed

1:50

Rear Gate - Front Elevation
1:10

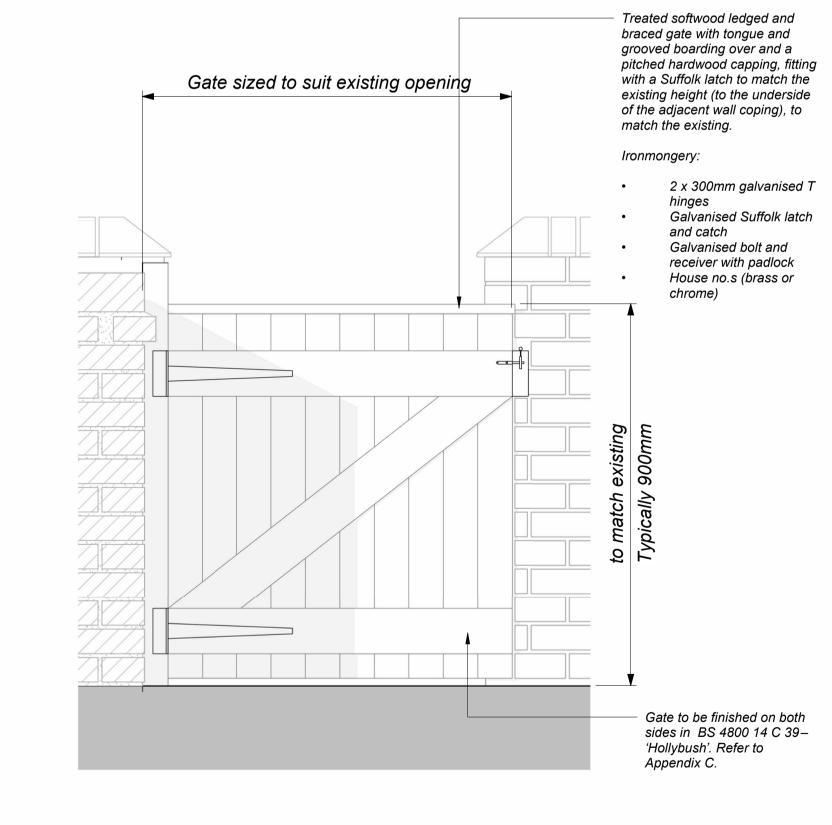

7 Rear Gate - Rear Elevation
1:10

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01/05/2025 MP Issued for Stage 4 Costing 02/04/2025 MP 24/03/2025 MP Issued for LBC Issued for Review 19/03/2025 MP 04/03/2025 MP DATE BY Issued for Review DESCRIPTION

Cheshire East Council CEF Crewe, Warm & Healthy Homes


243231 Dorfold / Betley / Tollitt - Brick Copings
Details to Boundary & Part Walls

JOB NUMBER

SIZE SCALE A1L As indicated P06 S3 - For Review & Comment/

DRAWING NUMBER 243231-PUR-02-XX-DR-A-3201 **PURCELL**

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APPENDIX B - 04 TOLLITT STREET

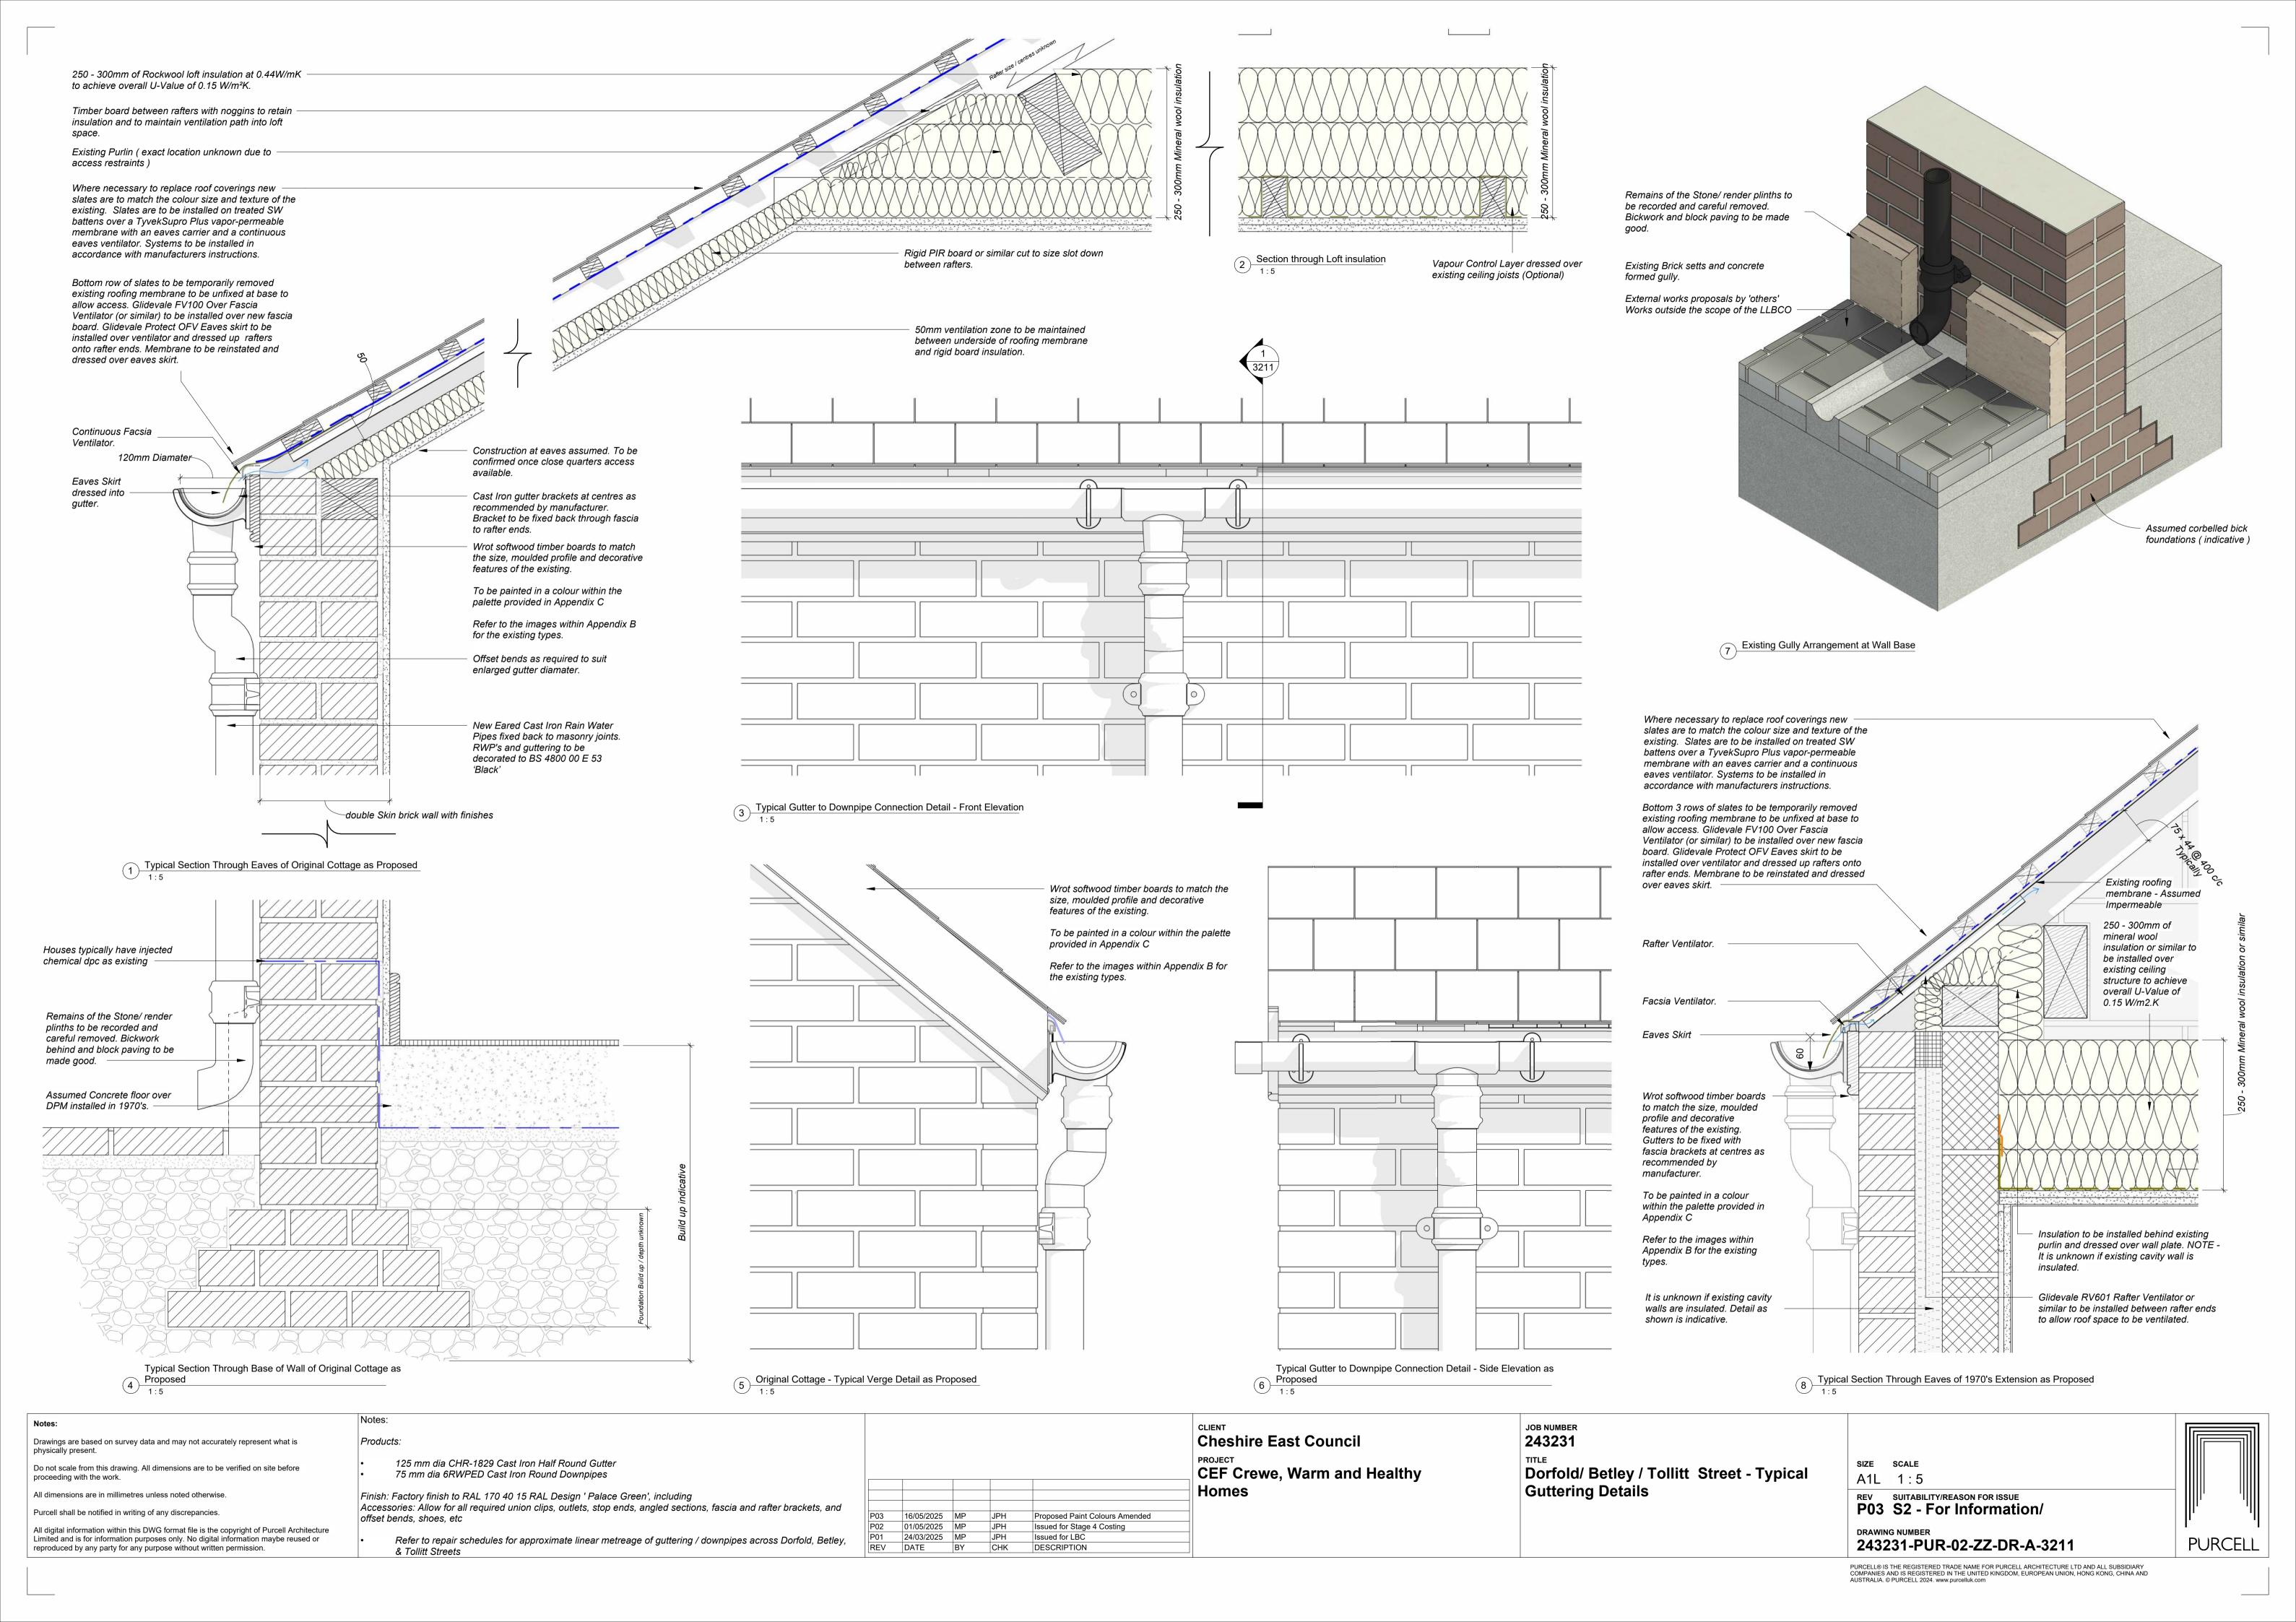Tollitt Street - Photo Reference

04/04/2025



Mark Popely

St James's Building 79 Oxford St Manchester M1 6FQ

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APPENDIX B - 04 TOLLITT STREET

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EXISTING PHOTO REFERENCE SCHEDULE

Photographs in the schedule below act as a reference for 'like for like' replacements, where the proposal is required to match the existing fabric. Proposals should be submitted to the Local Planning Authority for approval prior to the ordering of any materials and commencement of works.

Items	Description	Photo Reference
Chimney Pots	Replacement chimney pots are to be cream clay and match the existing in size. Cream clay pepper pot ventilators are advisable where appropriate to keep the weather out of redundant flues.	
Coping to Chimney Stacks	Replacement buff stone copings are to match existing in size, profile and geology. Where original stone coping has been previously been replaced with brick. Renewal of is to be on a like for like basis as the existing.	

Blue Clay Ridge Tiles	These may be new or salvaged, plain or flaunched but must match the existing in colour, size/profile and finish of the existing.	
		'Uncapped' Ridge Tile Variant 'Flaunched' Ridge Tile Variant
Replacement Joinery for Barge boards to projecting rear gable	Wrot softwood timber boards to match the size, moulded profile and decorative features of the existing.	
Replacement Joinery for Barge boards to Gable end	Wrot softwood timber boards to match the size, moulded profile and decorative features of the existing.	
Replacement Joinery for Barge boards to	Wrot softwood timber boards to match the size, moulded profile	

APPENDIX B - 04 TOLLITT STRE	ET	
front projecting front Gable	and decorative features of the existing.	
Replacement blue clay pitched wall coping on the rear boundary.	New or salvaged blue clay triangular coping bricks to match the colour, size and finish of the existing.	
Replacement of blue engineering brick copings to side/ party yard walls	New or salvaged blue clay engineering brick to form a coping on side walls and act as a DPC. To match the colour size and texture of the existing. Refer to drawing 3201 for coping detail.	

Replacement yard gates

Treated softwood ledged and braced gate with tongue and grooved boarding over and a pitched hardwood capping, fitting with a Suffolk latch to match the existing height (to the underside of the adjacent wall coping), to match the existing. Refer to drawing 3201 for typical gate detail.



APPENDIX C - COLOUR SWATCHES

Dorfold, Betley and Tollitt Street

16/05/2025



Revisions

P01 - 04/04/2025 P02 - 16/05/2025

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COLOUR SWATCHES FOR DECORATION SCHEME

Colour references in the schedule below act as a reference where the proposal is required to redecorate to match the existing fabric. Proposals should be submitted to the Local Planning Authority for approval prior to the ordering of any materials, and commencement of works.

Items	Photo Reference	Description	Colour Reference
External Front Door		BS 4800 14 C 39 'Hollybush'	
Rear Gate		BS 4800 14 C 39 'Hollybush'	
Rainwater Goods		BS 4800 00 E 53 'Black'	

APPENDIX C - COLOUR SWATCHES						
Front Porch Gates		BS 4800 00 E 53 'Black'				
Window frames		BS 4800 10 C 31 'Ivory / Champagne / Buttermilk'				
Window / threshold Stone Sills		BS 4800 14 C 39 'Van Dyke'				

External Rear Door	01120	Allow for either:	
		BS 4800 10 C 31 'Ivory / Champagne / Buttermilk'	
		BS 4800 14 C 39 'Hollybush'	
Front Porch timber work.		BS 4800 10 C 31 'Ivory / Champagne / Buttermilk'	

Barge Boards and	BS 4800 10 C 31	
Facias	'Ivory / Champagne /	
	Buttermilk'	